



or Rock Leopard Brewery, located at 13 Wagtail Walk, London, SE2 9FE. In This Electrical Layout Pl mpliance with all applicable electrical codes and standards for brewery s and guidelines have been adhered to: designing this layout, we ha installations. The following re-

- British Standards (BS): The layout follows **BS 7671 (18th Edition)**, ensuring safety and regulatory compliance with wiring installations in the UK. This standard covers requirements for circuit design, fault protection, and grounding, which are critical in brewery environments with high energy loads and wet conditions.
- 2. Electrical Safety Standards: We have also incorporated **UK Health and Safety Executive (HSE) guidelines** specific to brewery installations. These include provisions for safe electrical practices, risk mitigation for high-load machinery, and ventilation to avoid overheating and moisture build-up.
- 3. IP Ratings and ATEX Directives: We have used equipment that complies with **Ingress Protection (IP) ratings* appropriate for moisture-prone areas and **ATEX standards** where applicable, ensuring explosion-proofing and safety in environments where flammable vapors may be present.
- 4. Three-Phase Power Requirements: As breweries typically require significant electrical power, especially for three-phase motors and pumps, this plan accounts for adequate power distribution, aligned with guidelines for industrial settings (as advised by the Asia Brewers Network).

This document certifies that the electrical plan is up-to-date with all required codes, prioritizing safety, operational efficiency, and regulatory compliance throughout the installation at Rock Leopard Brewery.



CALLING BELL



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OWNER:

GENERAL ARRANGEMENT PLAN

ROCK LEOPARD BREWERY 13 WAGTAIL WALK, LONDON, SE2 9FE

SEAL:

Release for construction


ELECTRICAL LIGHTING PLAN

NOV, 24.

E. 1





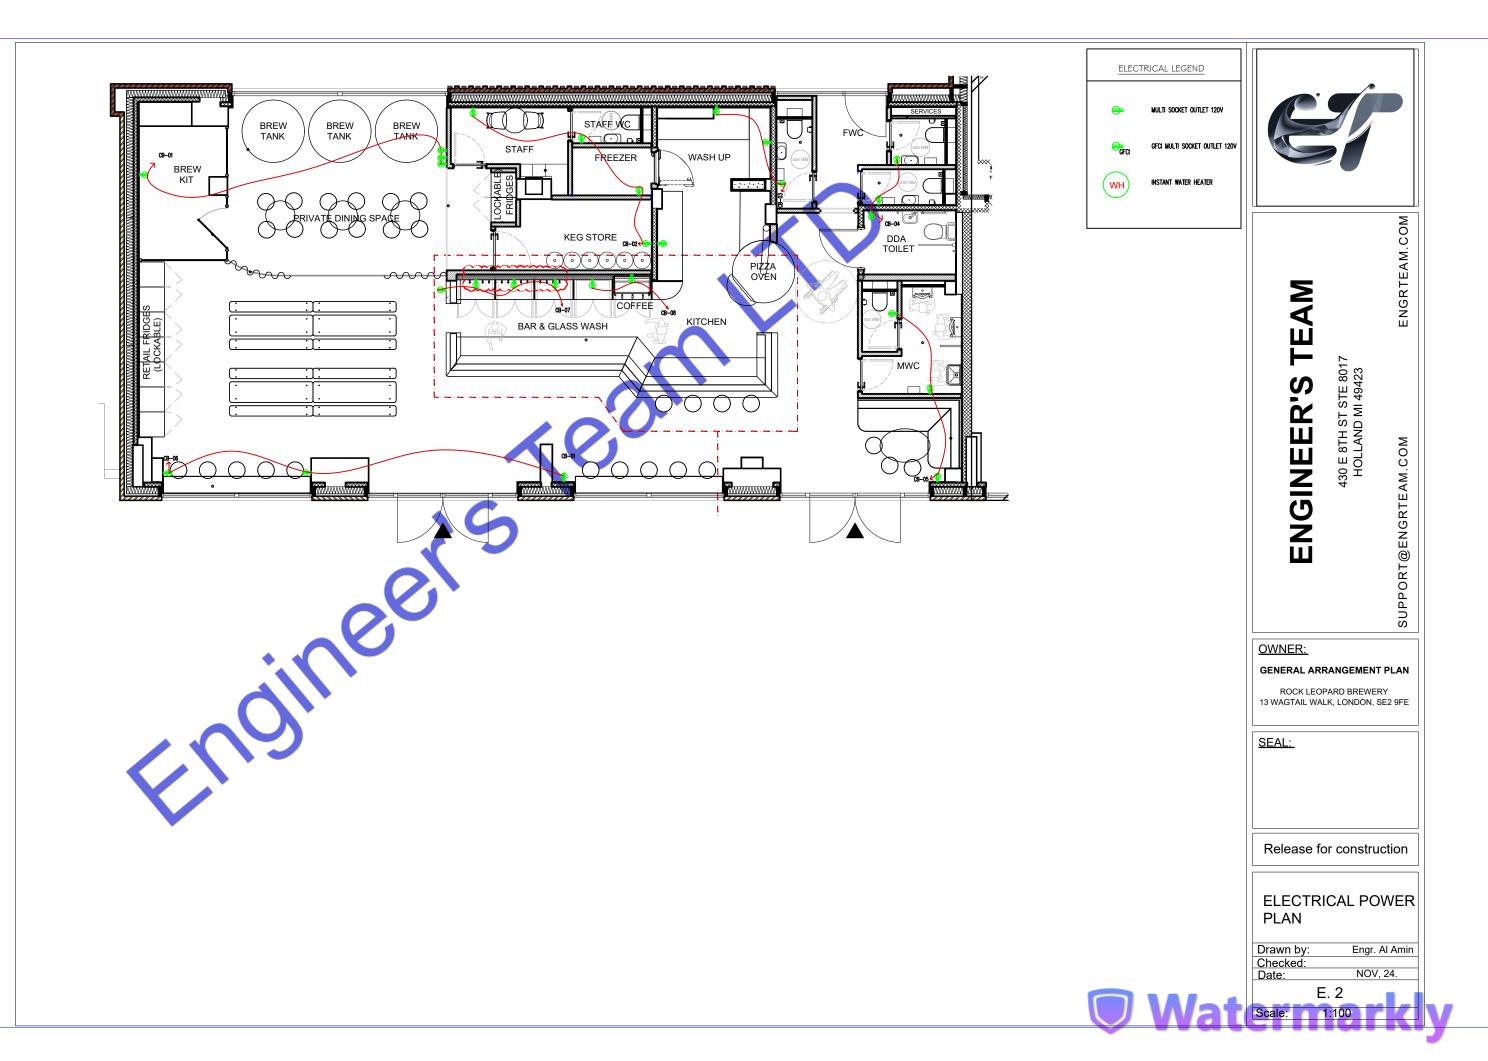


230/415 VOLT 3 PHASE 4 WIRE ELECTRICAL SERVICE						
ITEM	CONN. LOAD (VA)	DEMAND F.	DEMAND LOAD (WATTS)	TOTAL (AMPS)		
LIGHTING	1100	125%	1375			
WATER HEATERS	2000	100%	2000			
EQUIPMENT	10866	65%	7063			
HVAC LOADS	24618	100%	24618			
SUB-TOTAL	38584		35056			
LARGEST MOTOR	0	125%	0			
TOTAL @ 230V/415 V	38584		35056	51		



								PANEL -MAIN						
LOAD SERVED	CKT #	TYPE	BKR TRIP	WIRE SIZE	PHASE A	PHASE I	PHASE C		PHASE A	BKR TRIP	WIRE SIZE	TYPE	CKT #	LOAD SERVED
	1		80	#3	8206				1100	20	#12		2	LIGHTING LOAD
IVAC-7 TONS	3		120	#1/0		8206			2000	100	#3		4	WATER HEATER
	5		120	#1/0			8206		3000	120	#1/0		6	CB-1
CB-4	7		20	#12	500				1500	20	#1/0		8	CB-2
CB-5	9		100	#3	500				500	120	#1/0		10	CB-3
CB-6	11		100	#3	500		_		1000	20	#12		12	CB-7
CB-8	13		0	#12	1683				0	0	#12		14	SPARE
_	15		0	#12		1683	_		0	0	#12		16	SPARE
PARE	17		0	#12	• 0				0	0	#12		18	SPARE
TOTAL VA PHASE A		V			11389				9100					20489
TOTAL VA PHASE B 9889											9889			
TOTAL VA PHASE B														
TOTAL VA PHASE B							8206							8206
TOTAL VA PHASE B TOTAL VA PHASE C							8206							8206
							8206							8206 38584
TOTAL VA PHASE C							8206							
TOTAL VA PHASE C	 	S BY S	YSTEM	VOLTA	AGE (PHAS	SE)	8206	230			AMPS			
TOTAL VA PHASE C TOTAL VOLT-AMPS	 -AMF	S BY S	YSTEM	VOLTA	AGE (PHAS	SE)	8206	230			AMPS			38584
TOTAL VA PHASE C TOTAL VOLT-AMPS DIVIDE TOTAL VOLT					AGE (PHAS	,	8206	230	2	10	AMPS			38584

Material 🔦 🧲	
Name	Watt
CEILING MOUNT ROUND LED LIGHT	20W
WALL MOUNT LED LIGHT	10W
CEILING MOUNT 2"X2" SQUARE LED LIGHT	40W
HANGING LIGHT	20W

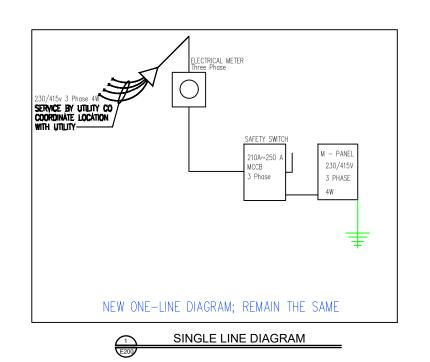



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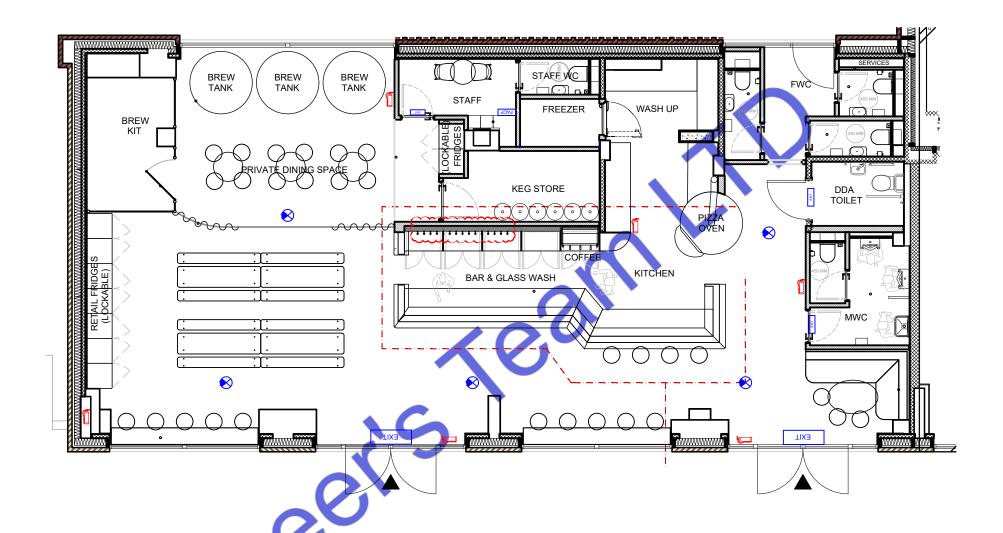
ELECTRICAL LOAD SHEDULE PLAN

Drawn by: Engr. Al Amin
Checked:
Date: NOV, 24.

E. 3

cale: 1:100





	LEGENDS
SYMBOLS	DESCRIPTION
	SMOKE DETECTOR
(H	SOUNDER
•	MANUAL CALL POINT
\bigotimes	HEAT DETECTOR
FACP	FIRE ALARM CONTROL PANEL
EXIT	WHITE LED EXIT & EMERGENCY LIGHT
	FIRE EXTINGUISHERS



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FIRE SAFTY PLAN

Drawn by: Engr. Al Amin Checked: NOV, 24.

F. 1

Note:


agtail Walk, London, SE2 9FE, has been developed in full This Fire Safety Plan f elines. The plan adheres to the following updated codes and compliance with th


- ler 2005 (RRO): This foundational legislation mandates that the responsible person Regulatory ensures fire emergency response plans are in place and updated. It includes requirements for fire safety manage ns, and clear evacuation routes.
- egulations 2022: These regulations, introduced to implement the Grenfell Tower Inquiry's recommendations, include mandatory updates for building safety. Key requirements under these regulations cover:
- Monthly checks on firefighting lifts, equipment, and evacuation aids.


 Installation and maintenance of a secure information box with up-to-date floor plans and building layouts for quick access by emergency services.
- Placement of wayfinding signage to guide occupants in low visibility and indicate floor levels.

 Displaying comprehensive fire safety instructions accessible to all occupants, detailing evacuation procedures and
- 3. Approved Document B (Fire Safety) of the Building Regulations 2019: This document provides essential guidelines for structural fire precautions, materials used, and escape routes to protect building integrity and ensure safe evacuation.

These measures ensure that the Rock Leopard Brewery's Fire Safety Plan aligns with the latest fire safety standards, addressing all required precautions and protections to safeguard occupants and property.

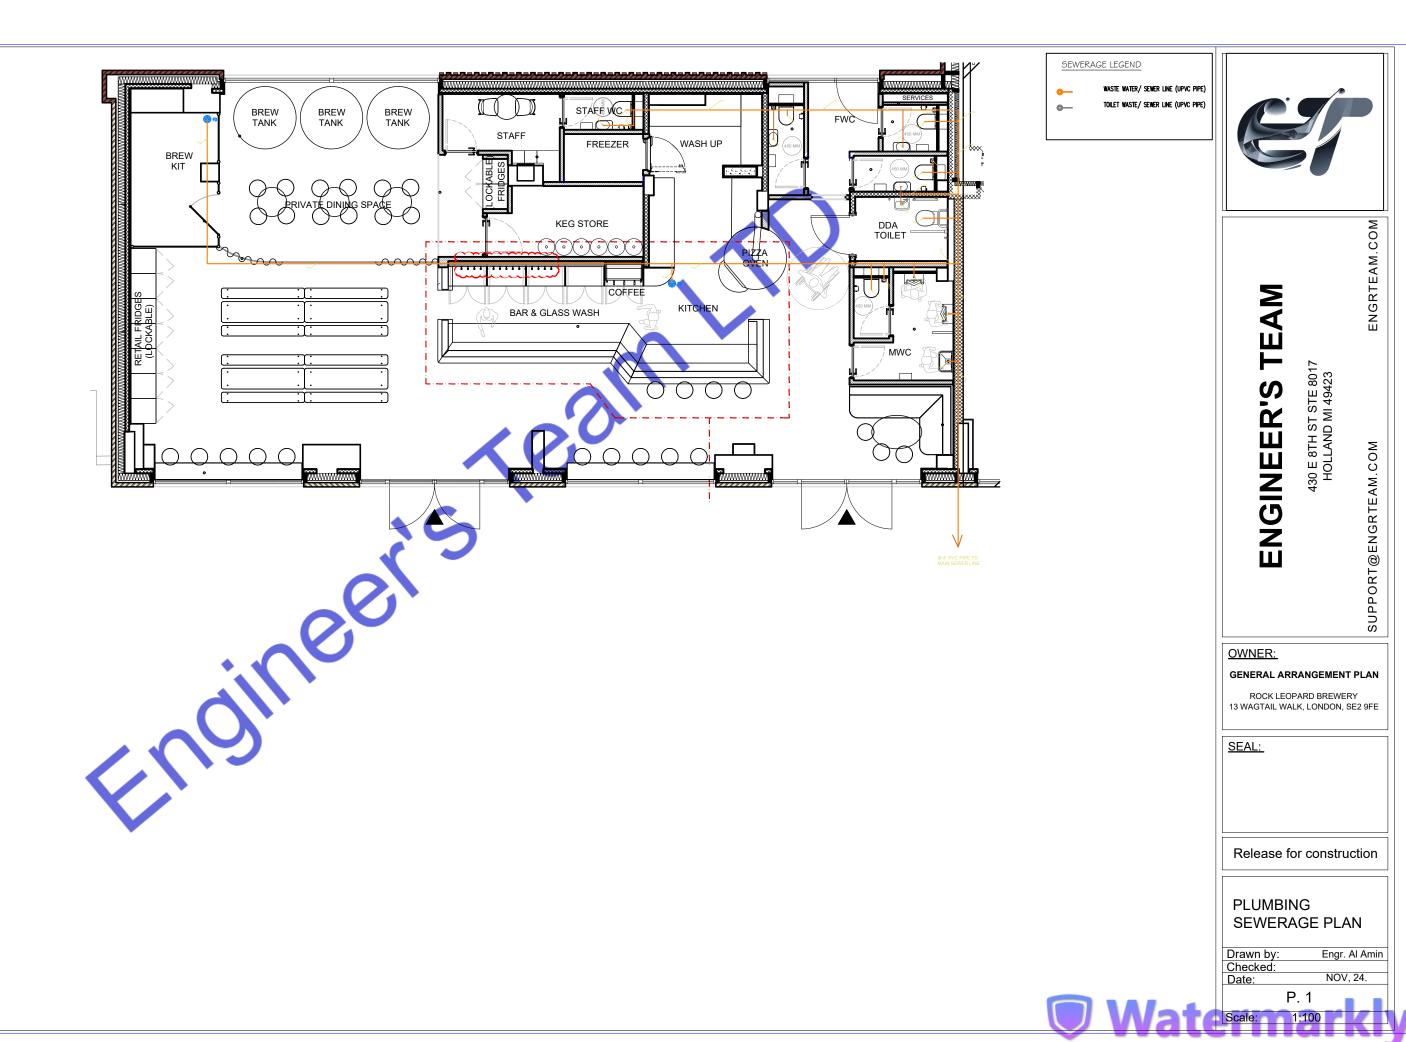

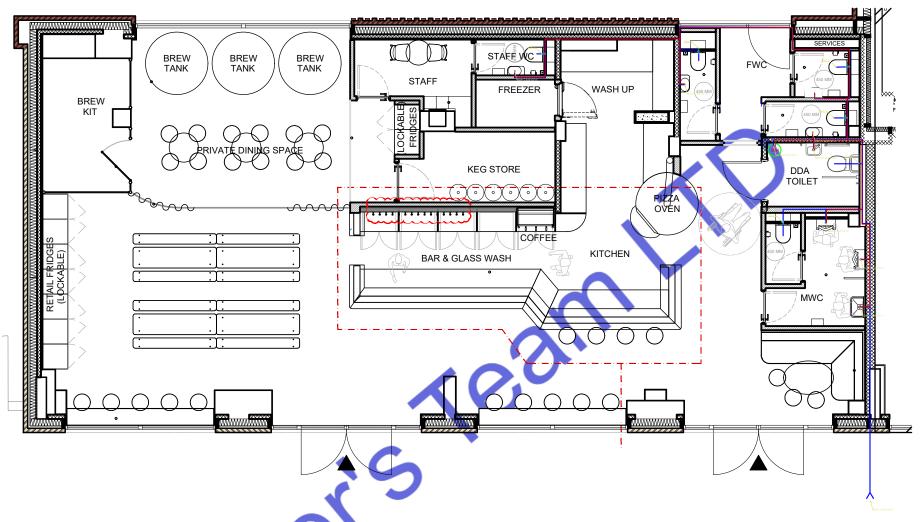

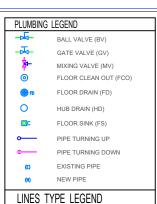

COLD WATER LINE (CW) HOT WATER LINE (HW)

GAS LINE (G)



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PLUMBING WATER SUPPLY PLAN

Drawn by: Engr. Al Amin Checked: NOV, 24.

P. 2

Note:


k, London, SE2 9FE" has been prepared in full This Plumbing Layout Plan fo Key codes and standards applied include: compliance with current


- Building Regula age and waste disposal standards, ensuring effective wastewater udes specific sizing and material requirements to minimize risk and ensure management and health and safety
- ations 1999: Governing all aspects of water supply systems, this regulation notes efficient water usage, particularly relevant for brewery operations.
- 3. BS EN 806 & BS 8558: Establishing guidelines for the design, installation, and maintenance of potable water systems to meet safety standards and avoid contamination in commercial settings.
- 4. Updated Part L (2023): Implementing energy efficiency requirements for heating and hot water systems. Compliance here aligns with the industry's push towards sustainability and efficiency, particularly in reducing carbon impact for high-use water facilities like breweries.
- 5. Future Homes Standard (FHS): Although fully effective in 2025, aspects of this evolving standard have been proactively incorporated, focusing on minimizing carbon emissions and preparing for future regulatory requirements in commercial

This comprehensive adherence to standards ensures that the plumbing systems at Rock Leopard Brewery not only meet current safety and efficiency criteria but also anticipate future regulatory expectations, supporting both operational and environmental sustainability.

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Scale: 1:100



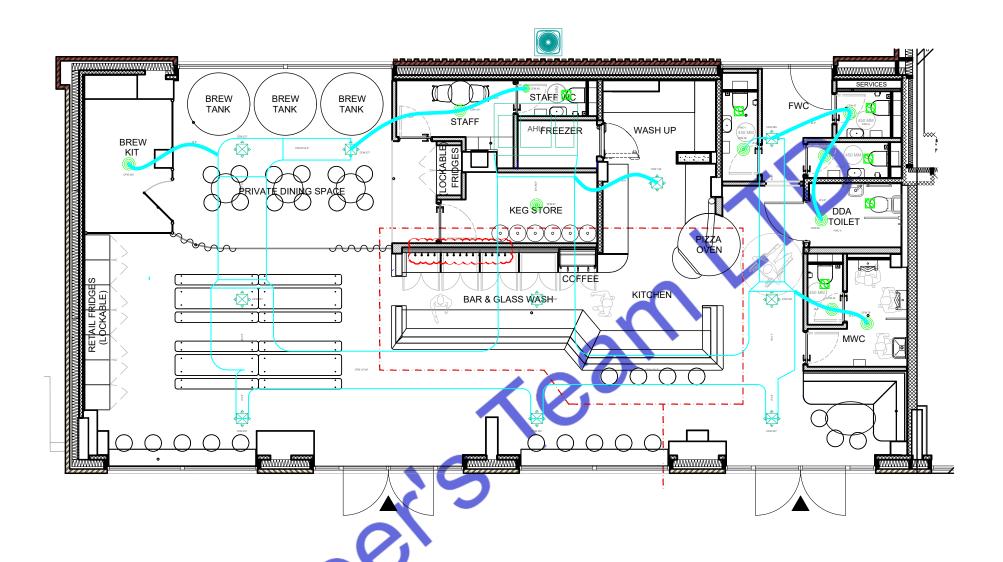

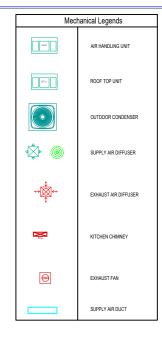

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GENERAL ARRANGEMENT PLAN

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HVAC LAYOUT PLAN

Drawn by: Engr. Al Amin
Checked:
Date: NOV, 24.

H. 1

cale: 1:100

EXHAUST FAN SCHEDULE

EXHAUST FAIN SCHEDULE									
MARK	SERVING	CFM	SP	WATTS	RPM	VOLTAGE	MAKE MODEL	NOTES	FAN TYPE
EF-1	BATHROOM	50	-	50	460	120/60/1	Broan-NuTone 688		IN-LINE
EF-2	KITCHEN	1600	-	78	1291	115/60/1	HOODMART 28D-1600-FF		IN-LINE

NOTES


- 1. COMPLETE W/BACKDRAFT DAMPER.
- 2. PROVIDE THERMOSTATIC CONTROL DEVICES
- 3. INTERLOCK TO OPERATE WHENEVER RTU'S OPERATE.
- 4. MAINTAIN A MINIMUM CLEARANCE OF 10'-0" FROM ALL INTAKE AIR FANS AND ALL ROOF TOP UNITS OUTSIDE AIR INTAKE OPENINGS.

Note:


This HVAC layout plan for Rock Leopard Brewery has been created in compliance with all relevant and updated codes and standards required in London, UK. The design meets the following key regulations:

- Part F Ventilation: Ensures adequate ventilation with attention to air quality, airflow, and humidity control. This includes
 adherence to specifications on preventing condensation and maintaining proper indoor air quality for industrial spaces.
- Part L Conservation of Fuel and Power: Addresses energy efficiency, optimizing the HVAC system to reduce energy
 consumption while achieving the necessary heating and cooling performance. This part requires updates every few
 years to meet the evolving UK energy conservation standards.
- Part B Fire Safety: Ensures all HVAC components are placed and designed to minimize fire hazards and provide safe egress, including provisions for smoke extraction where necessary. This compliance supports occupant safety in the case of an emergency.
- 4. BS EN 378 Refrigeration Systems and Heat Pumps: This British Standard governs the safe operation of refrigerants, ensuring environmental safety and adherence to UK standards for systems using refrigeration.
- 5. CIBSE Guide B Heating, Ventilating, Air Conditioning, and Refrigeration: As advised by the Chartered Institution of Building Services Engineers (CIBSE), this guide ensures the HVAC system follows best practices in mechanical and environmental engineering, emphasizing energy efficiency, thermal comfort, and safety.


This layout has been meticulously planned to meet all these standards, ensuring it aligns with current UK codes and promotes operational efficiency, safety, and environmental responsibility.

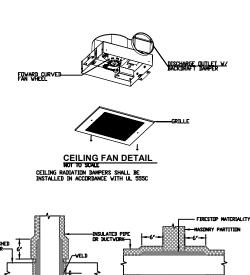




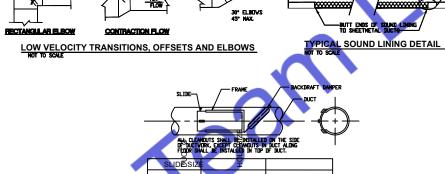

LOW VELOCITY ELBONIS LOW VELOCITY TRANSITIONS LOW VELOCITY OFFSETS

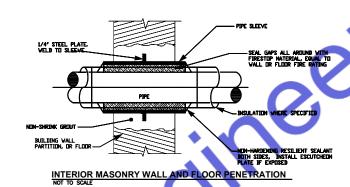

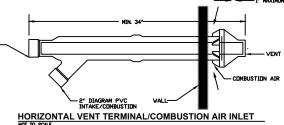

6° 4° X 6° 6° X 8°
CLEAN OUT / INSPECTION DETAIL

IN LAKE COMBOS LIDA	
HORIZONTAL VENT TERMINAL/COMBUSTION AIR INLET	
NOT TO SCALE NOTE-PLASTIC PIPE AND FITTINGS USED TO VENT APPLIANCES SHALL BE INSTALLED IN	
ACCORDANCE WITH THE APPLIANCE MANUFACTURER'S INSTRUCTIONS, PLASTIC PIPE VENTING	
MATERIALS LISTED AND LABELED IN ACCORDANCE WITH UL 1738 SHALL BE INSTALLED IN	
ACCORDANCE WITH THE VENT MANUFACTURERS INSTALLATION INSTRUCTIONS, FLUID PVC PIPING	

DESIG	Type (refer to details)	SERVICE	AIR FLOW RANGE (CFM)	NOMINAL SIZE/ DESCRIPTION (INCH)	INLET/ NECK SIZE (IN)	BASIS OF DESIGN/REMARKS
A	REGISTER	SA	0-50	6x4	470	300RL, BORDER TYPE A
В	REGISTER	SA	51-100	6x6 OR 10X4	6"#	300RL, BORDER TYPE A
С	REGISTER	SA	101-150	10x6	79	300RL, BORDER TYPE A
D	REGISTER	SA	151-200	12x6	8"#	300RL, BORDER TYPE A
E	REGISTER	SA	201-250	14x6	9"4	300RL, BORDER TYPE A
F	RG	RA/EA	0-100	6x6	6:6	350RL, BORDER TYPE A
G	RG	RA/EA	101-200	8x8	8x8	350RL, BORDER TYPE A
н	RG	RA/EA	201-300	10x10	10x10	350RL, BORDER TYPE A
1	RG	RA/EA	301-450	12x12	12x12	350RL, BORDER TYPE A
J	RG	RA/EA	451-600	14x14	14x14	350RL, BORDER TYPE A
К	RG	RA/EA	601-800	16x16	16x16	350RL, BORDER TYPE A
L	RG	RA/EA	801-1100	18x18	18x18	350RL, BORDER TYPE A
M	RG	RA/EA	1101-1300	20x20	20x20	350RL, BORDER TYPE A
N	RG	RA/EA	1301-1600	22:22	22x22	350RL BORDER TYPE A

DRYER DETAIL


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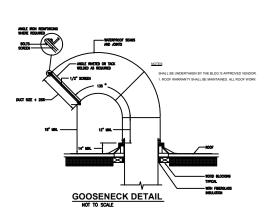
1. REFER TO ARCHITECT DRAWINGS FOR TYPE OF CELLING.

2. MODEL MUNIBERS IN "BASIS OF DESIGN" ARE TITUS

3. PROVIDE HEAVY DUTY FRAME AND CORE WHERE MULINTED IN FLOORS.

RETURN	GAS VENT & COMBUSTION AIR TURNING SUPPLY
FL	
GAS <u>-FIRED A</u> n.t.s.	IR HANDLING UNIT DETAIL



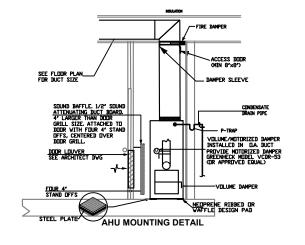



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HVAC PLAN

Drawn by: Engr. Al Amin
Checked:
Date: NOV, 24.

H. 2

Scale:

1:10