

230/415 VOLT 3 PHASE 4 WIRE ELECTRICAL SERVICE										
ITEM	CONN. LOAD (VA)	DEMAND F.	DEMAND LOAD (WATTS)	TOTAL (AMPS)						
LIGHTING	1000	125%	1250							
WATER HEATERS	2000	100%	2000							
EQUIPMENT	15000	65%	9750							
HVAC LOADS	-	100%	-							
SUB-TOTAL	18000		13000							
LARGEST MOTOR	0	125%	0							
TOTAL @ 230V/415 V	18000		13000	57						



							ELECTRIC	CAL	_ PANEL	-MAIN						
LOAD SERVED	CKT #	TYPE	BKR TRIP	WIRE SIZE	PHASE	A PHASE	B PHASE C		PHASE	APHASE	A PHASE /	BKR TRIP	WIRE SIZE	TYPE	CKT #	LOAD SERVED
	1		20	#12	340				1500			20	#12		2	Dough Mixer 30L
Oven	3		20	#12		340				275		20	#12		4	Under Counter Fridge - 282L
	5		20	#12			340				250	20	#12		6	Sandwich Display Fridge -160L
Under Counter Fridge - 420L	7		20	#12	230				240			20	#12		8	Meat Slicer
Salad Bar Fridge	9		20	#12		530				4600		25	#12		10	2 Group Coffee Machine
Under Counter Dishwasher	11		20	#12			3900				730	20	#12		12	Soft Drink Fridge -110L
Hot Water Tank - 100L	13		20	#12	2000				450			20	#12		14	Storage Fridge - 1200L
Electric Hand Dryer	15		20	#12		1000				50		15	#12		16	32 inch Digital POS
Lighting Load	17		20	#14			1000				-	-	-		18	SPARE
TOTAL VA PHASE A					2570				2190							4760
TOTAL VA PHASE B						1870				4925						6795
TOTAL VA PHASE C							4240				980					5220
	_															
TOTAL VOLT-AMPS																16775
DIVIDE TOTAL VOL	T A14	nc nv c	VCTEM	VOLT	VCE (DIT	ACE)				230			AMPS			73
DIVIDE TOTAL VOL	_I-AMI	73 01 3	ISIEM	VOLIA	AGE (FII	ASE)				230			AMPS)		13
DIVIDE TOTAL VOL	T-AM	PS BY T	HREE F	PHASE	VOLTAG	E DIVIDER	₹			1.734			AMPS	3		42
											<u> </u>					
TOTA	AL CO	NECTED	LOAD	(AMPS	S) @ 12	5%				53						
MAIN TYPE AND AMPERE RATING										60~80 AMP MCCB						
						PANEL	FEEDER SIZE	=	- SEE RI	SER DIAG	RAM					

EQUIPMENT SCHEDULE										
tem # I	Room	Name	Finish	Dimensions (mm)	Power Re (W)	Power (V)	Quantity	Supplier	Product Code	Notes
1	Bar	Dough Mixer 30L	Premium Stainless Steel	W770xD550xH850	1500W	230V/ 1 PHASE	1	Adexa Catering Equipment Direct	SH30	Professional Spiral Dough Mixer 30 Litres Fixed Head Fixed Bowl 2 Speeds
2	Bar	Under Counter Fridge - 282L	Stainless Steel	W1360xD700xH860	275W	230V/ 1 PHASE	1	Adexa Catering Equipment Direct	THP2100TN	Commercial Refrigerated Counter 2 doors Depth
3	Bar	Sandwich Display Fridge -16	0L White	W880xD568xH686	250W	230V/ 1 PHASE	1	Adexa Catering Equipment Direct	CW160	Display Merchandiser Fridge 160 litres 2 shelves White
4	Bar	Meat Slicer	Aluminium	W420xD265xH390	240W	230V/ 1 PHASE	1	Adexa Catering Equipment Direct	BF220ROUGE	Commercial Meat slicer 8"/220mm Aluminium Coated Red
5	Bar	2 Group Coffee Machine	Stainless Steel	W710xD590xH533	4600W	220V/ 3 PHASE	1	La Marzocco	N/A	The Linea PB, 2 Group
6	Bar	Till	Black	N/A	N/A	N/A	1	Toast	N/A	Toast Flex, Didigital Screen POS, IP54
7	Bar	Low Level Counter	Marble/Oak	N/A	N/A	N/A	1	TBC	N/A	800mm max height for accessiblity
8	Bar	Oven	Stainless Steel	W850xD842xH754	10250W	N/A	1	Rational Online UK	~6-1/1	Icombi Pro 6-1/1 with Steam extraction hood
9	Bar	Under Counter Fridge - 420L	Stainless Steel	W1795xD700xH950	230W	230V/ 1 PHASE	2	Adexa Catering Equipment Direct	2DRG32V	Commercial Refrigerated Counter 2 doors 2 drawers Depth 420L
10	Bar	Salad Bar Fridge	White	W1840xD688xH1410	530W	230V/ 1 PHASE	1	Adexa Catering Equipment Direct	CW571WHITE	Display Merchandiser Fridge 810 litres White
11	Bar	Soft Drink Fridge -110L	Black	W685xD620xH1450	730W	230V/ 1 PHASE	1	Adexa Catering Equipment Direct	VC14F102I	Multi Deck Refrigerator 110 litres with Night Curtain Black
12	Store	Under Counter Dishwasher	Stainless Steel	W565xD610xH825	3900W	230V/ 1 PHASE	1	Adexa Catering Equipment Direct	ADX50B	Commercial Dishwasher Premium 500mm basket 20 baskets/hour Break tank Drain Pump Detergent dosing pump, 62 dB(A)
13	Bar	Sink	Stainless Steel	W1000xD600xH900	N/A	N/A	1	Adexa Catering Equipment Direct	VS106LBS	Commercial Sink Stainless steel 1 bowl Left Bottom shelf Splashback, Adjustable feet
14	Store	Storage Fridge - 1200L	Stainless Steel	W1340xD845xH2000	450W	230V/ 1 PHASE	2	Adexa Catering Equipment Direct	R1200S	1200lt Commercial Refrigerator Stainless steel Upright cabinet Twin door GN2/1 Fan assisted cooling
15	Store	Storage Shelves	Powder Coated Steel	W1220xD610xH1980	N/A	N/A	1	Adexa Catering Equipment Direct	TY6101220	Industrial Shelving Unit Heavy duty 4 shelves 400 kg/shelf Powder coated steel
16	Store	Hot Water Tank - 100L	White	W440xD440xH990	2000W	220V	1	Amazon UK	B07PMDXYP5	Tesy Bi-light Electric Un-Vented Vertical Hot Water Cylinder - To be mounted high in line wih MEP services above - G3 registered installer required for installation
17	Store	Lockers	Grey	W900xD400xH1830	N/A	N/A	1	Adexa Catering Equipment Direct	SART238	Commercial Grey 6 Door Locker with 1 Shelf
18	Store	Sink	Stainless Steel	W1400xD600xH900	N/A	N/A	1	Adexa Catering Equipment Direct	DBS14060LEFT	Commercial Double Sink Stainless steel, 2 bowl left, 100mm Splashback, Adjustable Feet
19	Toilet	Electric Hand Dryer	Sprayed Nickel	W234xD100xH394	1000W	240V	1	Dyson UK	307170-01	Dyson Airblade V hand dryer, Hygienic performance with HEPA filter
20	Seating	Self Service Till/Kiosk	Black	N/A	N/A	N/A	1	Toast	N/A	Restaurant Self-Ordering Kiosks
21	Store	Handwash Sink	Stainless Steel	W400xD400xH240	N/A	N/A	1	Adexa Catering Equipment Direct	THHWR44	Commercial Hand wash sink Stainless steel Knee control, 79 dB(A)
22	Bar	32 inch Digital POS	Charcoal Black	W727.3xD28.5xH421.9	9 50W	100-240V	3	Samsung	LH32QMCEBGCX	E Samung 32" Smart Signage QM32C. Array of 3 units mounter in portait orientation.Uses100x100mm Vesamount.



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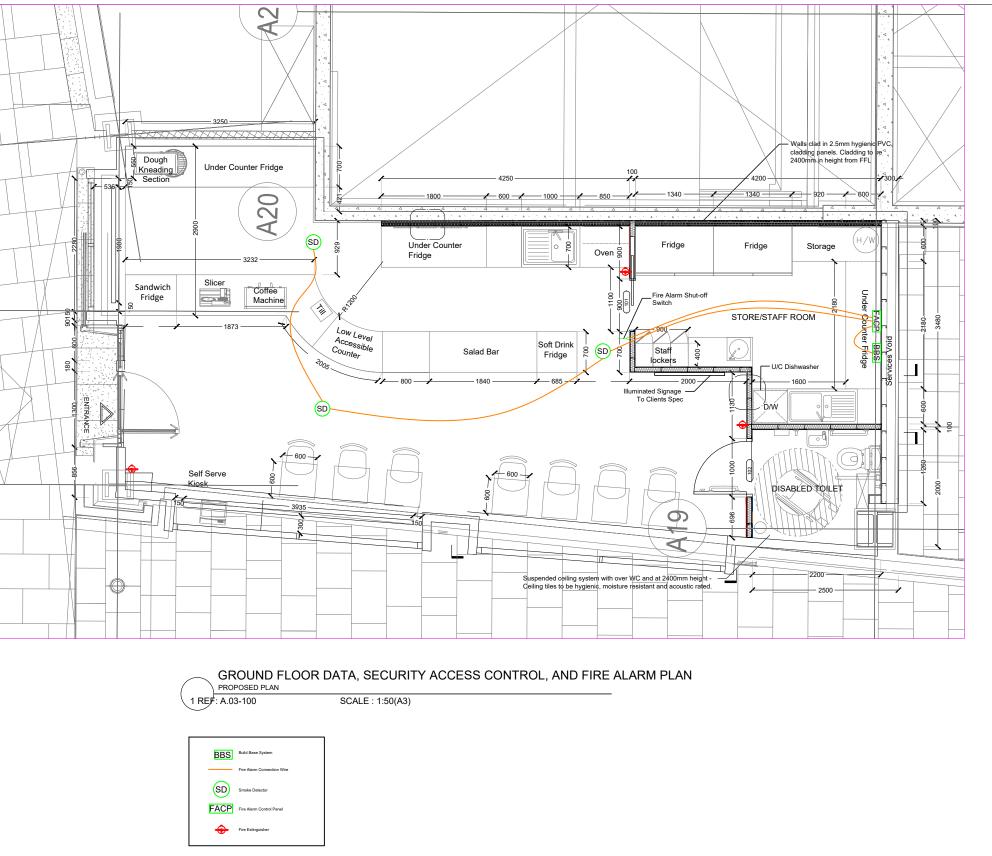
UNIT 5, 120 FENCHURCH, STREET, LONDON, EC3M 5BA

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ELECTRICAL LOAD SCHEDULE PLAN

Drawn by: Checked: Date: Engr. Al Amin FEB, 06. E. 3 Scale: 1:100





- Compliance with Standards and Regulations: This Fire Alarm Plan for UNIT 5, 120 Fenchurch Street, London, EC3M 5BA, has been meticulously developed in strict adherence to the latest British Standards and London, UK Product Approval Codes, ensuring the highest level of fire safety and regulatory compliance.
- Applicable Standards: BS 5839-1:2017: Code of practice for design, installation, commissioning, and maintenance of fire detection and fire alarm
- systems in non-domestic premises.

 BS 5839-8:2023: Code of practice for the design, installation, commissioning, and maintenance of voice alarm systems.
- System Design and Installation:
- Oystein Design and installation: The fire detection and alarm systems are designed to provide comprehensive coverage, incorporating both manual call points and automatic detection devices, as recommended for Category L1 systems under BS 5839-1:2017. Detection zones have been established to facilitate prompt
- identification of fire locations, with each zone not exceeding 2,000m2, in line with BS 5839-1:2017 guidelines.
- Audible alarm devices have been installed to achieve sound levels of at least 65 dB(A) in general areas and a minimum of 75 dB(A) of at least to db(A) in general areas and a minimum of 7, db(A) at the bedhead in sleeping accommodations, ensuring effective alerting of occupants, as specified in BS 5839-1:2017. Visual alarm devices, such as flashing beacons, have been incorporated in areas with high ambient noise levels to provide adequate warning to all occupants.
- 5. Manual Call Points:
- Manual call points are strategically located at all exits and within 45 meters of any point within the building, reducing to 25 meters in high-risk areas, facilitating prompt manual activation in case of fire, in accordance with BS 5839-1:2017.
- Power Supply:
 The system is equipped with a primary mains power supply and a secondary backup power source, capable of providing a minimum of 24 hours of standby power followed by 30 minutes of full alarm operation, ensuring system reliability during power outages, as per BS 5839-1:2017 requirements.
- Automatic Control Devices for Lighting:
 Incorporated within this Fire Alarm Plan are automatic control devices for lighting, designed to activate emergency lighting upon alarm activation, thereby facilitating safe occupant egress during emergencies.
- A comprehensive maintenance schedule has been established, including weekly testing of manual call points, monthly testing of backup power supplies, quarterly inspections by certified engineers, and annual full-system assessments, ensuring ongoing system integrity and compliance with BS 5839-1:2017.

This Fire Alarm Plan reflects our unwavering commitment to upholding the highest standards of fire safety, ensuring the well-being of all occupants within UNIT 5, 120 Fenchurch Street.



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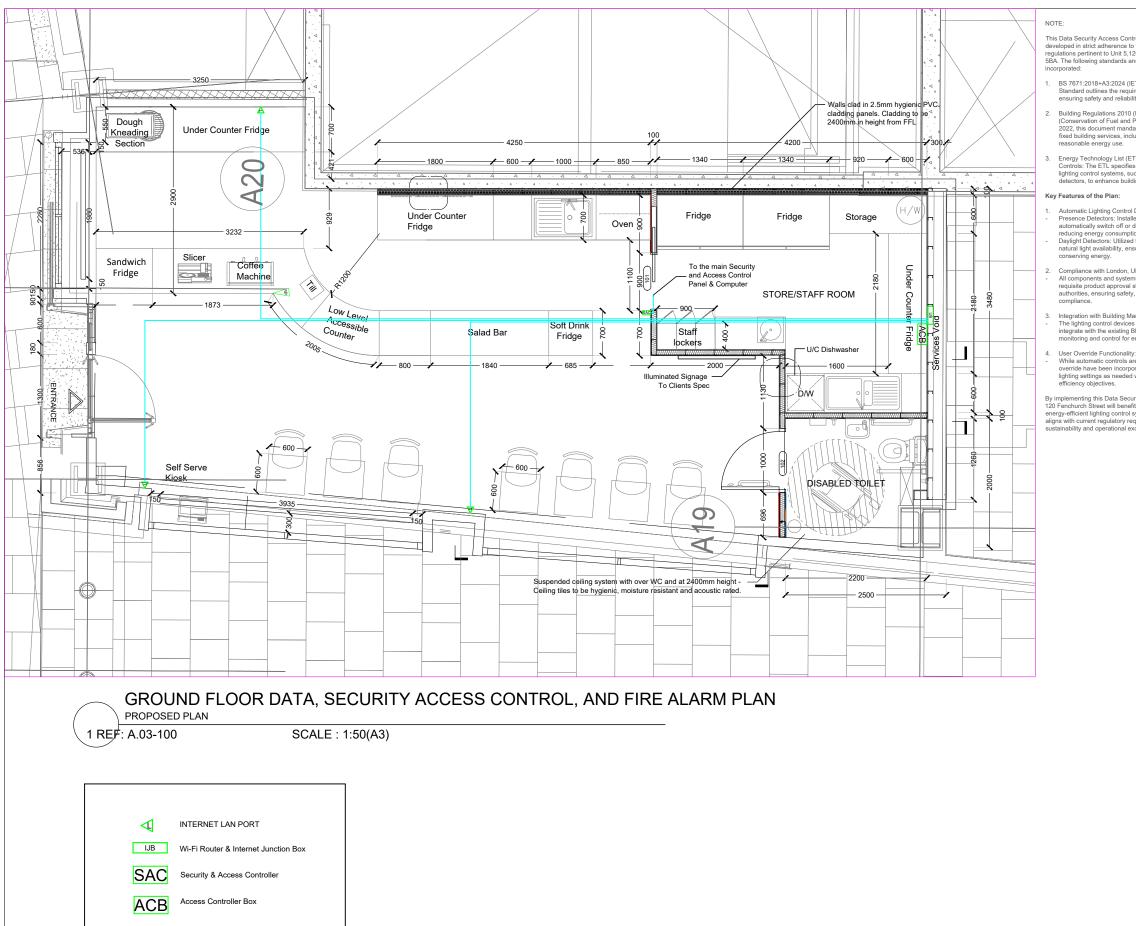
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DATA, SECURITY ACCESS CONTROL PLAN

Drawn by: Engr. Al Amin Checked: FEB, 06. Date: LV 1 1:100 Scale:



CAT 6 Internet Cable

This Data Security Access Control Plan has been meticulously developed in strict adherence to the most current codes and regulations pertinent to Unit 5,120 Fenchurch Street, London, EC3M 5BA. The following standards and guidelines have been thoroughly

- BS 7671:2018+A3:2024 (IET Wiring Regulations): This British Standard outlines the requirements for electrical installations, ensuring safety and reliability in electrical wiring systems.
- Building Regulations 2010 (England) Approved Document L (Conservation of Fuel and Power): Effective from June 15, 2022, this document mandates energy efficiency standards for fixed building services, including lighting systems, to ensure
- Energy Technology List (ETL) Criteria for Building Lighting Controls: The ETL specifies requirements for energy-saving lighting control systems, such as presence and daylight detectors, to enhance building energy efficiency.

- Automatic Lighting Control Devices:
- Presence Detectors: Installed to monitor occupancy and automatically switch off or dim lighting in unoccupied areas, reducing energy consumption.

 Daylight Detectors: Utilized to adjust artificial lighting based on
- natural light availability, ensuring optimal illumination while
- Compliance with London, UK Product Approval Codes: All components and systems specified in this plan meet the requisite product approval standards as mandated by London authorities, ensuring safety, reliability, and regulatory compliance.
- Integration with Building Management Systems (BMS): The lighting control devices are designed to seamlessly integrate with the existing BMS, facilitating centralized monitoring and control for enhanced operational efficiency.
- User Overrice Functionality:
 While automatic controls are in place, provisions for manual override have been incorporated, allowing occupants to adjust lighting settings as needed without compromising overall energy efficiency objectives.

By implementing this Data Security Access Control Plan, Unit 5 at 120 Fenchurch Street will benefit from a robust, compliant, and energy-efficient lighting control system. This approach not only aligns with current regulatory requirements but also promotes sustainability and operational excellence.



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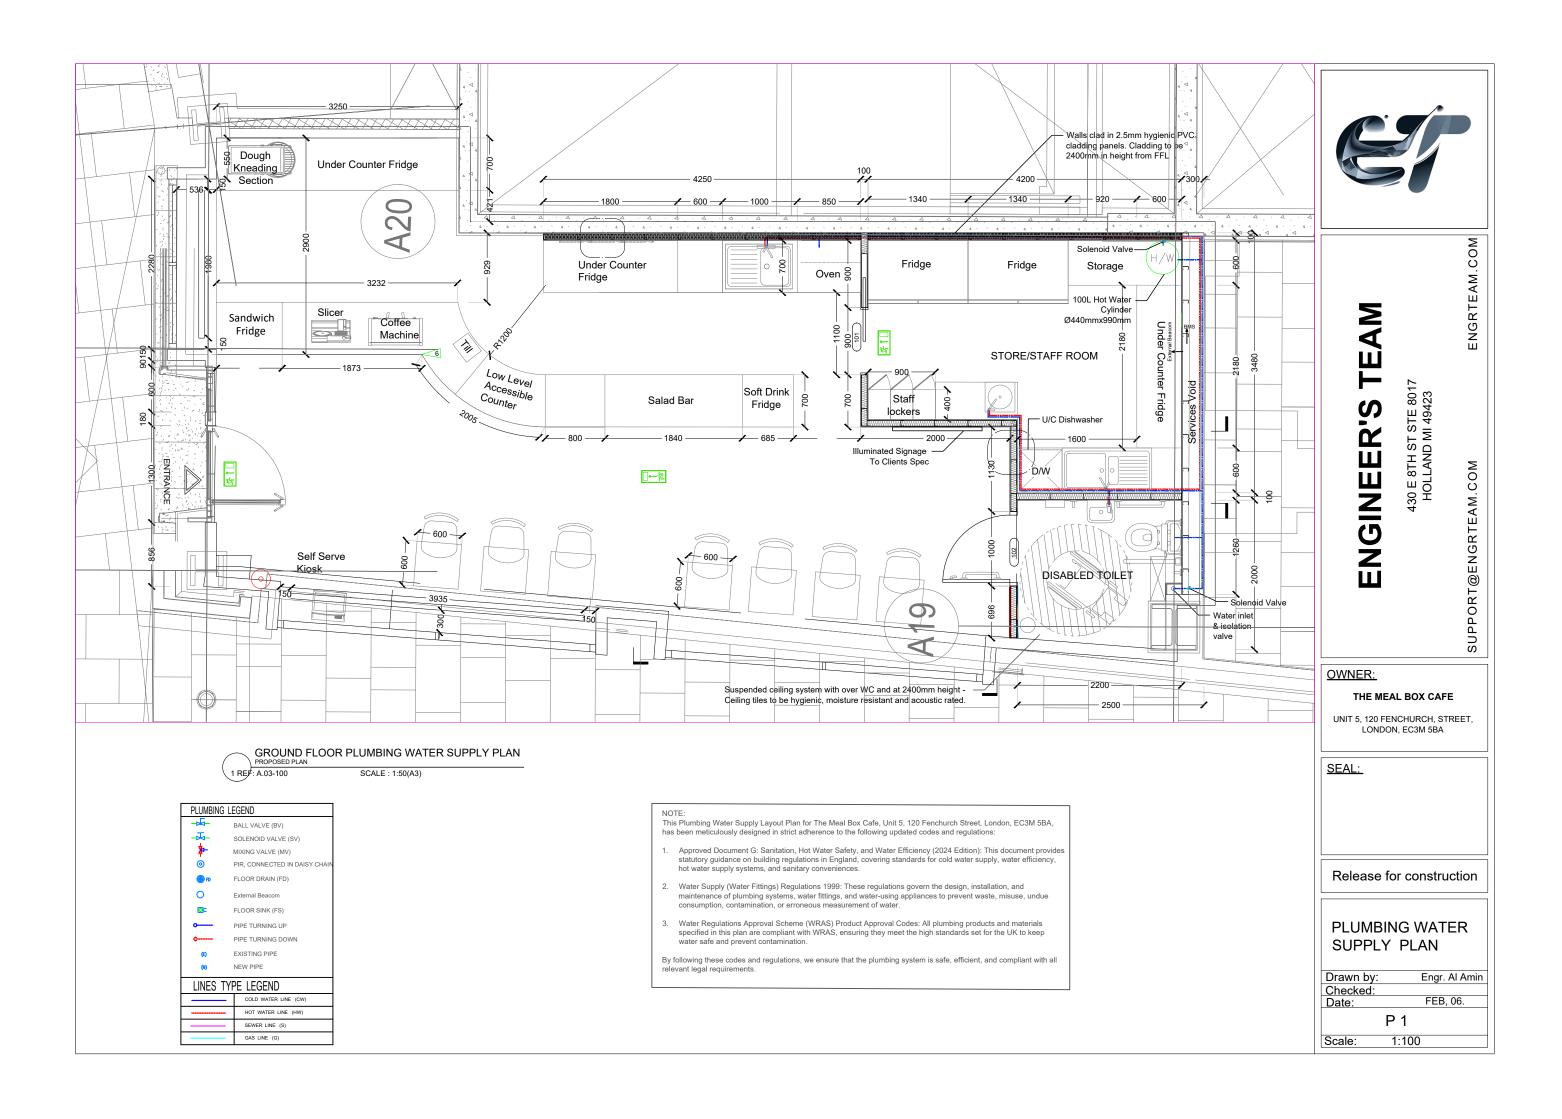
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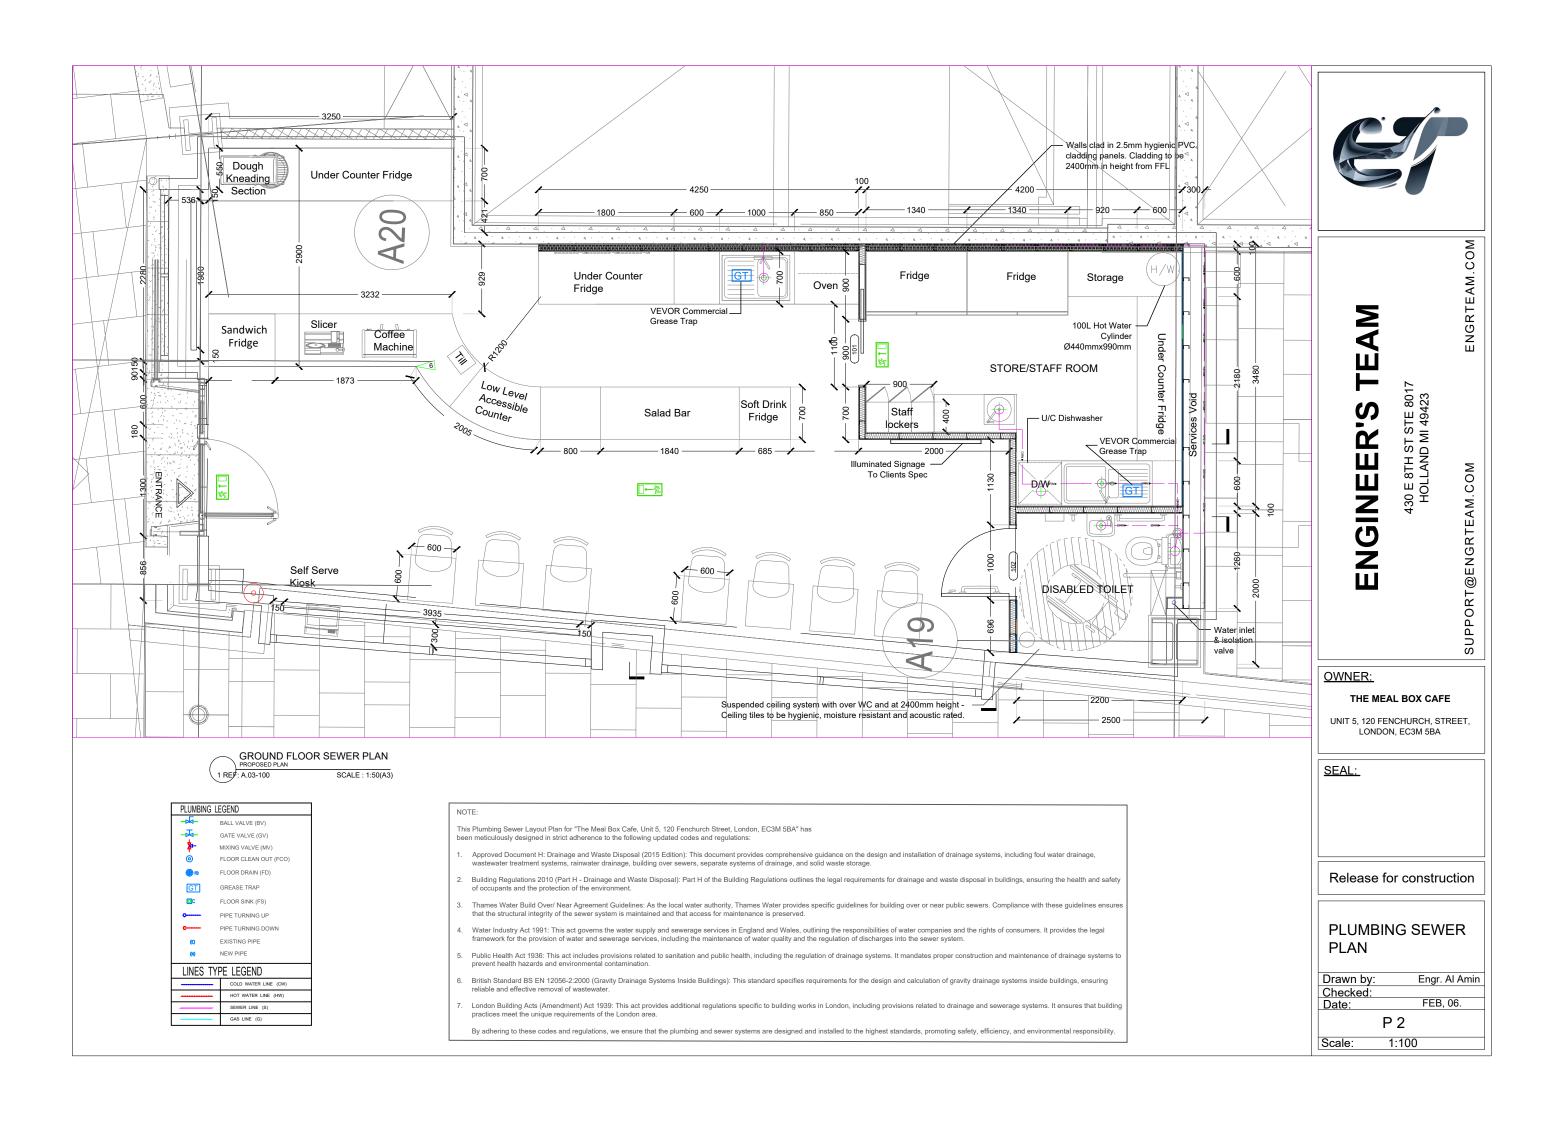
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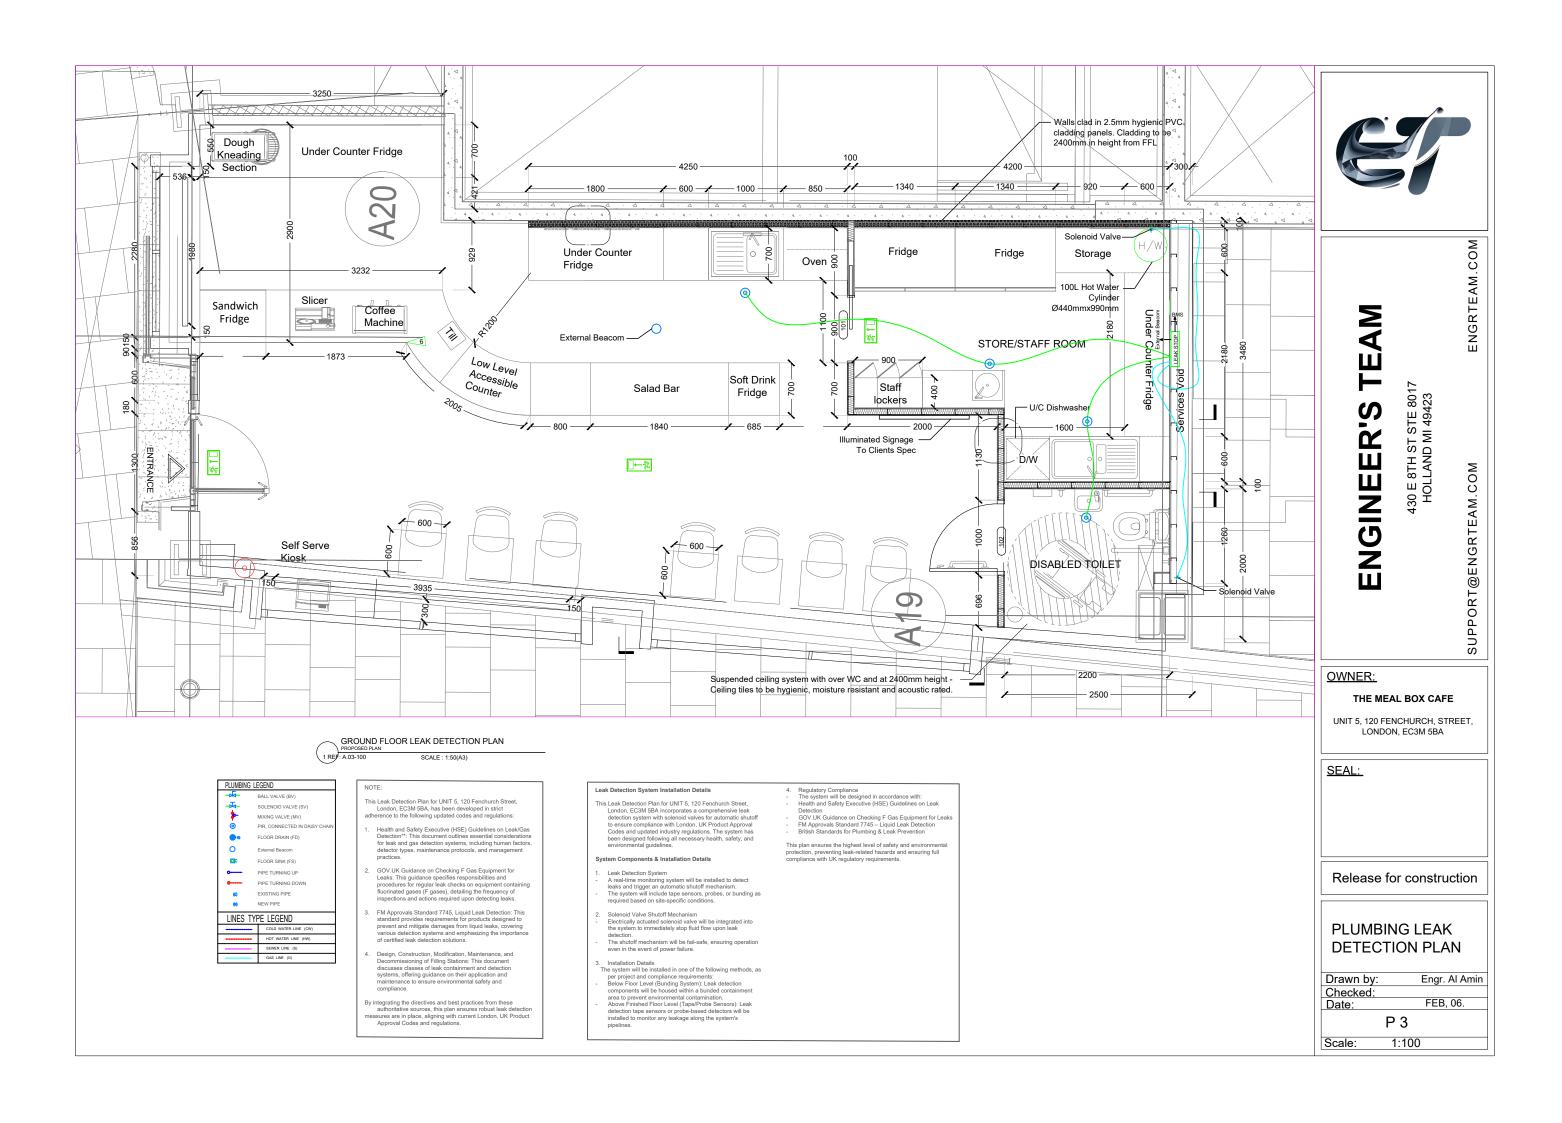
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FIRE ACCESS **CONTROLLER & INTERNET PLAN**

Drawn by: Engr. Al Amin Checked: FEB, 06. Date: LV2 1:100 Scale:







1.2 Alarm Units

1.2.8 Alarm Unit: FG-A

The FG-A alarm unit is a non-locating unit. It is designed to be used with analog sense cables as FG-ECS, FG-ECX, FG-ACS and FG-ACX for water and acids leak detection.

Responses on the FG-A alarm unit:

- In the case of a leak, an audible alarm is triggered. The red LED on the front panel is switched on and the leak relay is activated.
- In the case of cable break, an audible alarm is triggered, the yellow LED on the front panel is switched on and the cable break relay is acti-

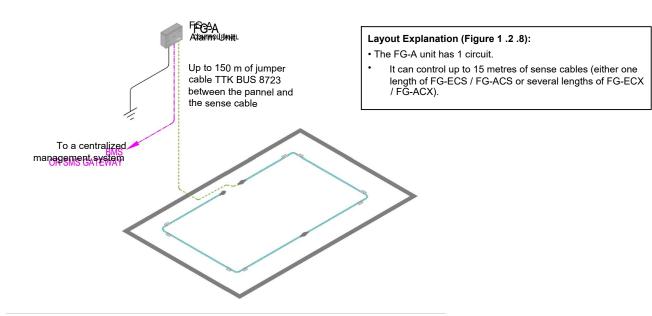


Figure 1: Layout with FG-A

1.2.9 Alarm Unit: FG-A-OD

The FG-A-OD alarm unit is a single sensor alarm unit. It is designed to be used exclusively with FG-OD hydrocarbon range of detectors for oil leak

- In the case of a leak, an audible alarm is triggered. The red LED on the front panel is switched on and the leak relay is activated.
- In the case of cable break, an audible alarm is triggered, the yellow LED on the front panel is switched on and the cable break relay is activated.

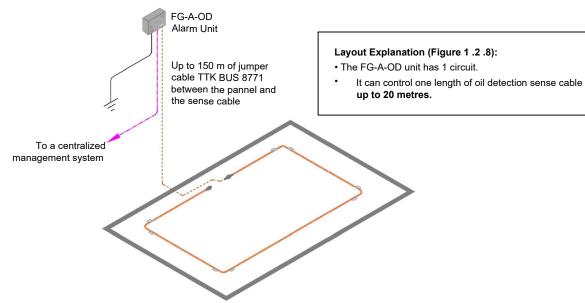


Figure 2: Layout with FG-A-OD



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PLUMBING LEAK **DETECTION PLAN**

Drawn by: Engr. Al Amin Checked: FEB, 06. Date: P 4 1:100 Scale:

