# 8090 County Road 293 Hico Texas, 76457









3RTEAM.C

\_

30 E 8TH ST STE 801 HOLLAND MI 49423

**ENGINEER'S T** 

SUPPORT@ENGRTEAM.COM

OWNER:

8090 County Road 293 Hico Texas, 76457

SEAL:


Release for construction

**INTRODUCE** 

Drawn by: Engr. Al Amin
Checked:
Date: NOV, 24.

A. 0

Scale: 1:100

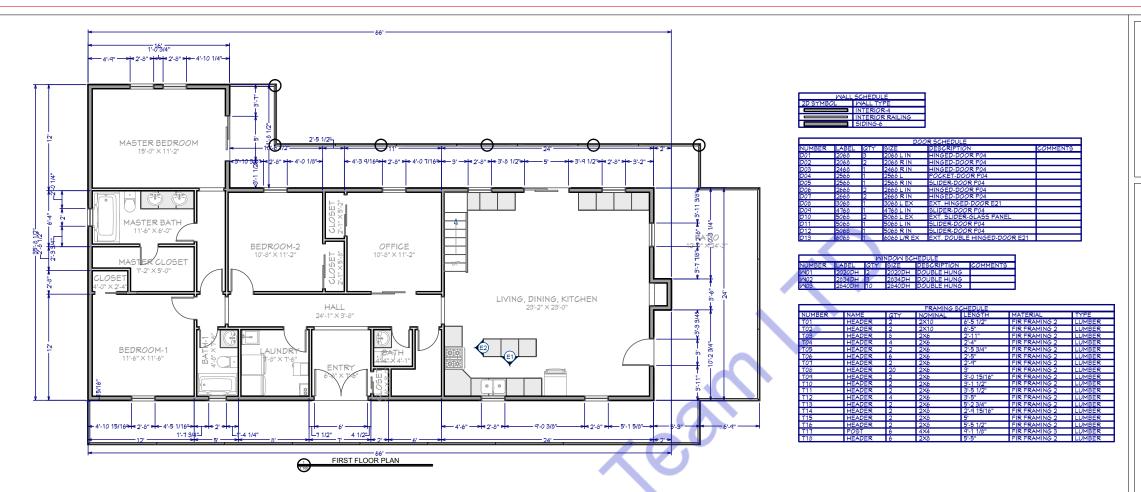




This architectural plan for '8090 County Road 293, Hico, Texas, 76457' is designed in strict adherence to all applicable updated codes and standards. The following codes and regulations have been considered in the creation of this plan:

- 2018 International Building Code (IBC) This plan follows the IBC as adopted by Texas for structural integrity, safety, and general building requirements for non-residential construction.
- 2. 2018 International Residential Code (IRC) -For any residential construction components, the IRC requirements are followed, including standards for construction, structural elements, and safety.
- 2020 National Electrical Code (NEC) Compliance with the NEC is ensured for all electrical installations, fixtures, and systems, covering residential and commercial electrical requirements.
- 2018 International Plumbing Code (IPC) -The IPC guidelines are incorporated for all plumbing fixtures and systems, ensuring safety, functionality, and code compliance.
- 2018 International Mechanical Code (IMC) -HVAC and other mechanical systems are designed following the IMC standards for system safety and energy efficiency.
- 2018 International Fire Code (IFC) -Fire safety measures within this plan comply with the IFC, addressing fire prevention, protection, and occupant safety protocols.
- 2015 International Energy Conservation Code (IECC) This code guides the energy efficiency aspects of the plan, ensuring that all elements meet Texas's energy conservation requirements.

Each aspect of this architectural plan has been developed to meet or exceed these standards, ensuring safety, efficiency, and compliance with the updated codes as of 2024.

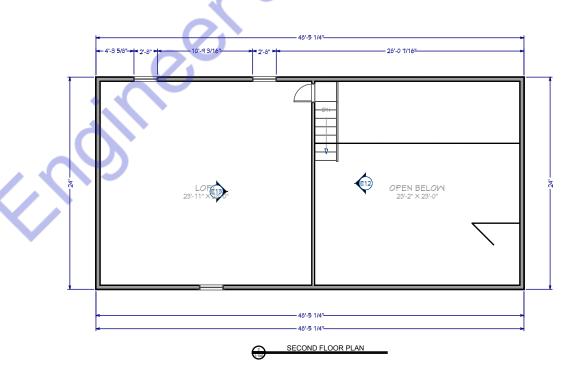



ENGRTEAM.COM

430 E 8TH ST STE 8017 HOLLAND MI 49423

**ENGINEER'S TEAM** 

SUPPORT@ENGRTEAM.COM

**OWNER:** 

8090 County Road 293 Hico Texas, 76457


SEAL:


Release for construction


**FLOOR PLAN** 

Drawn by: Engr. Al Amin
Checked:
Date: NOV, 24.

A. 1
Scale: 1:100

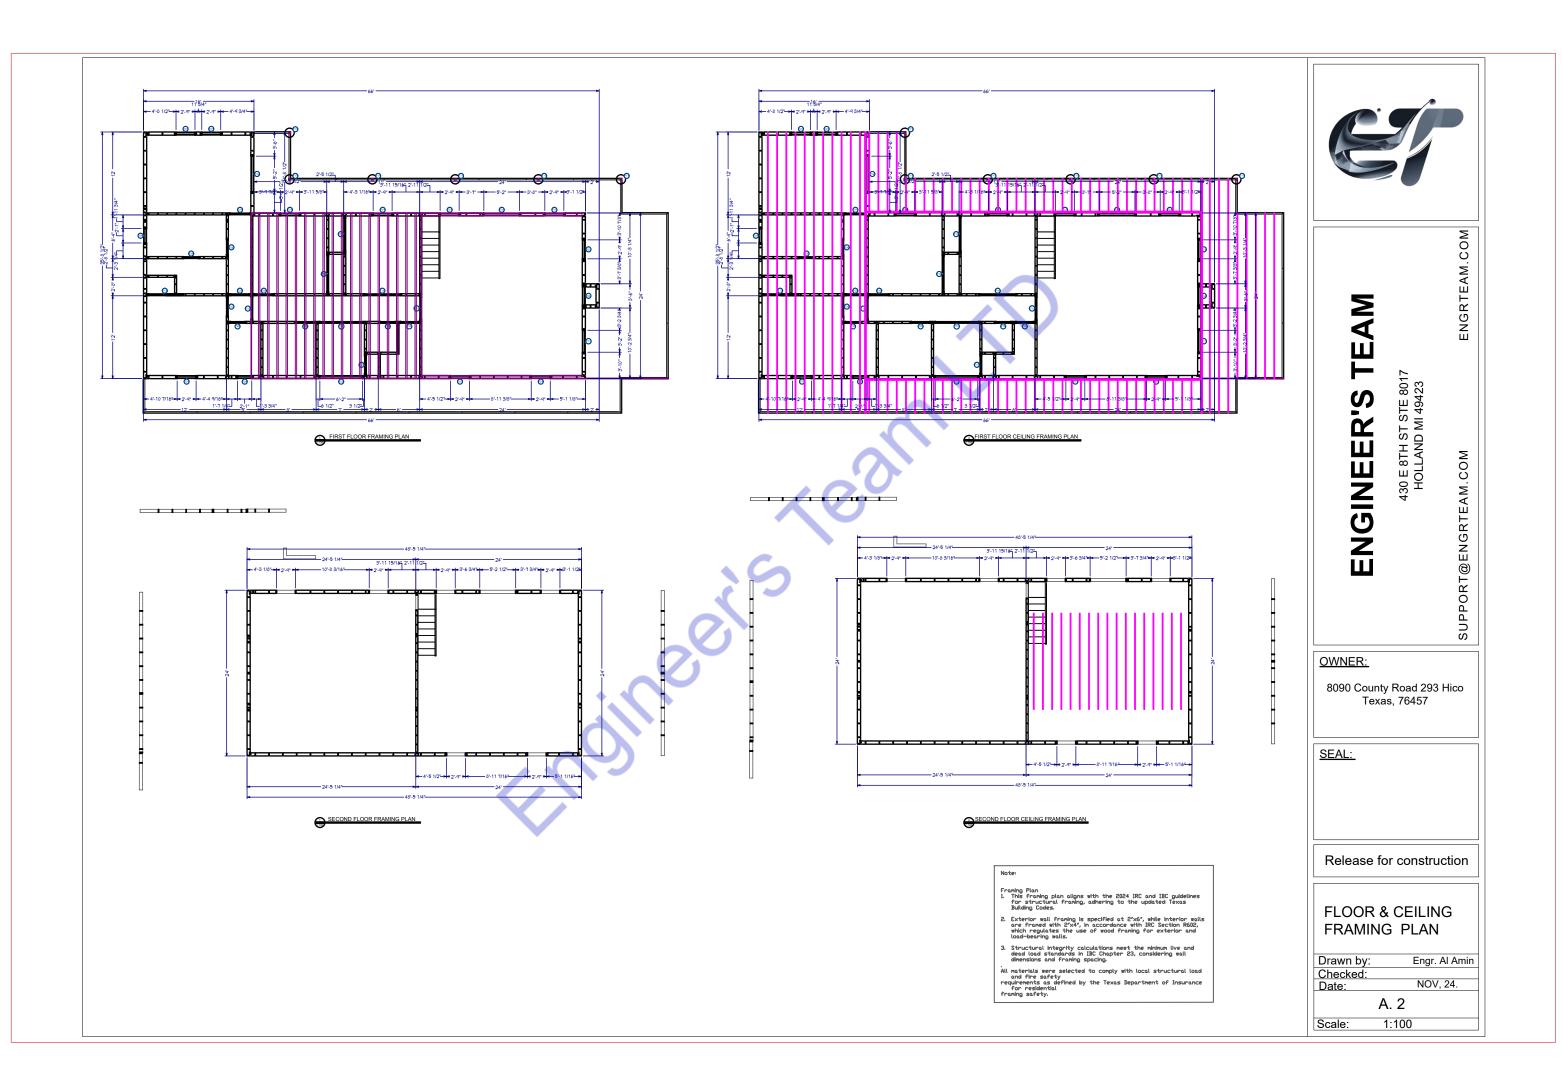

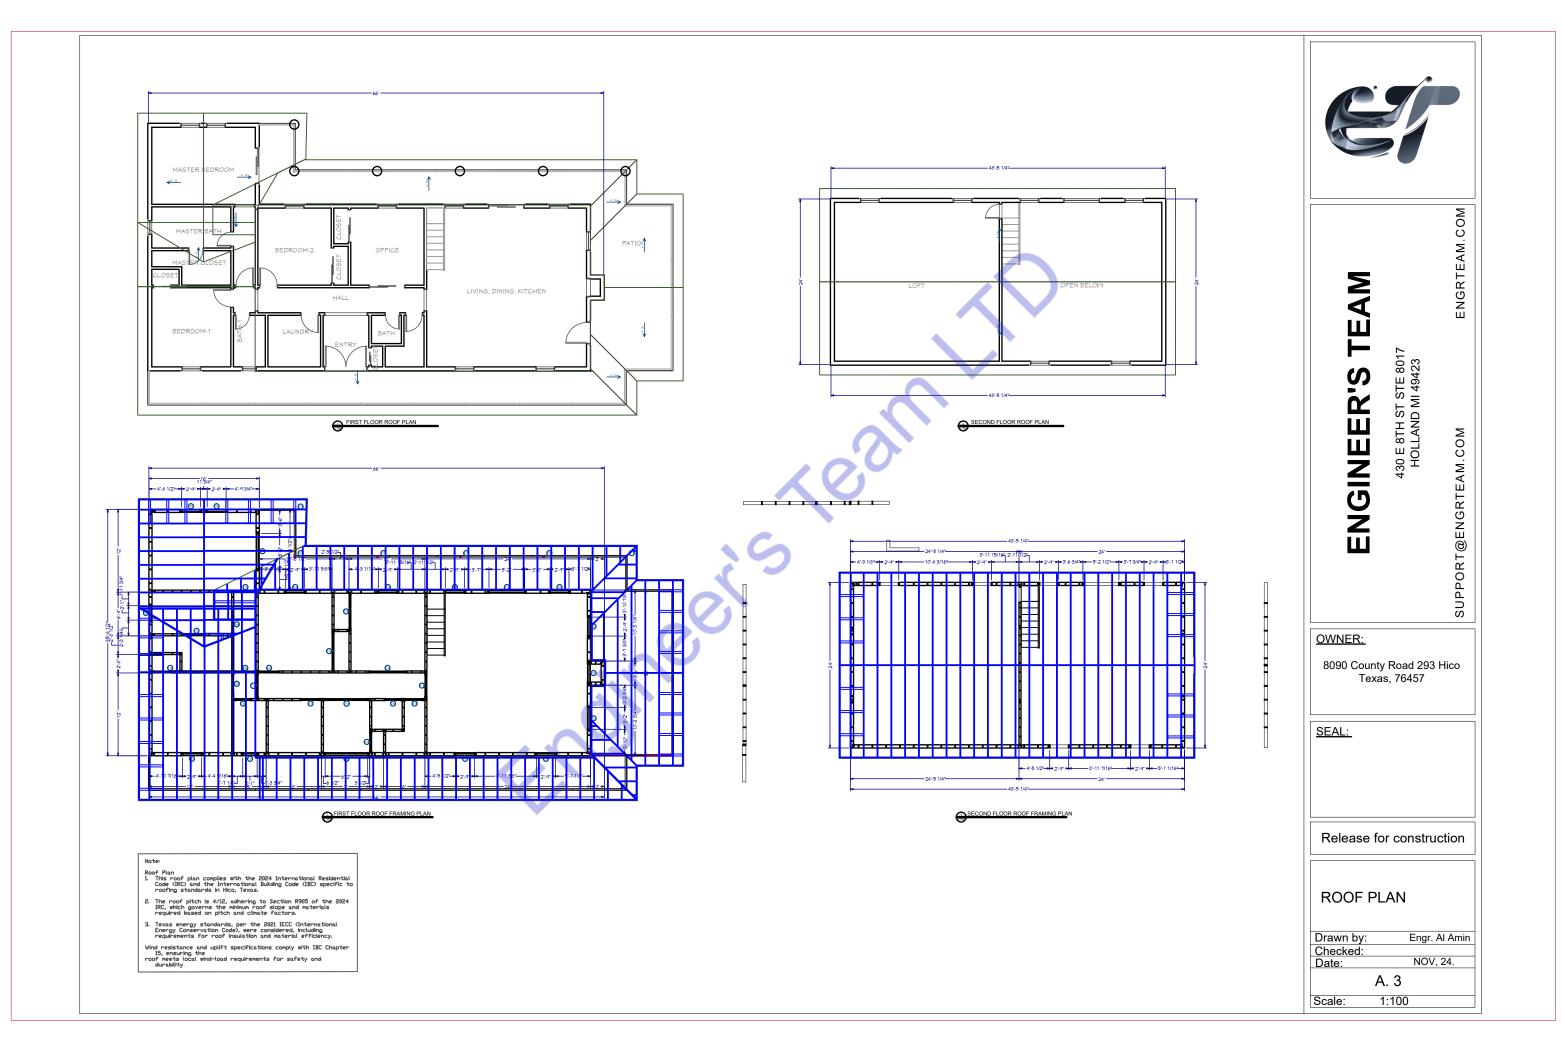

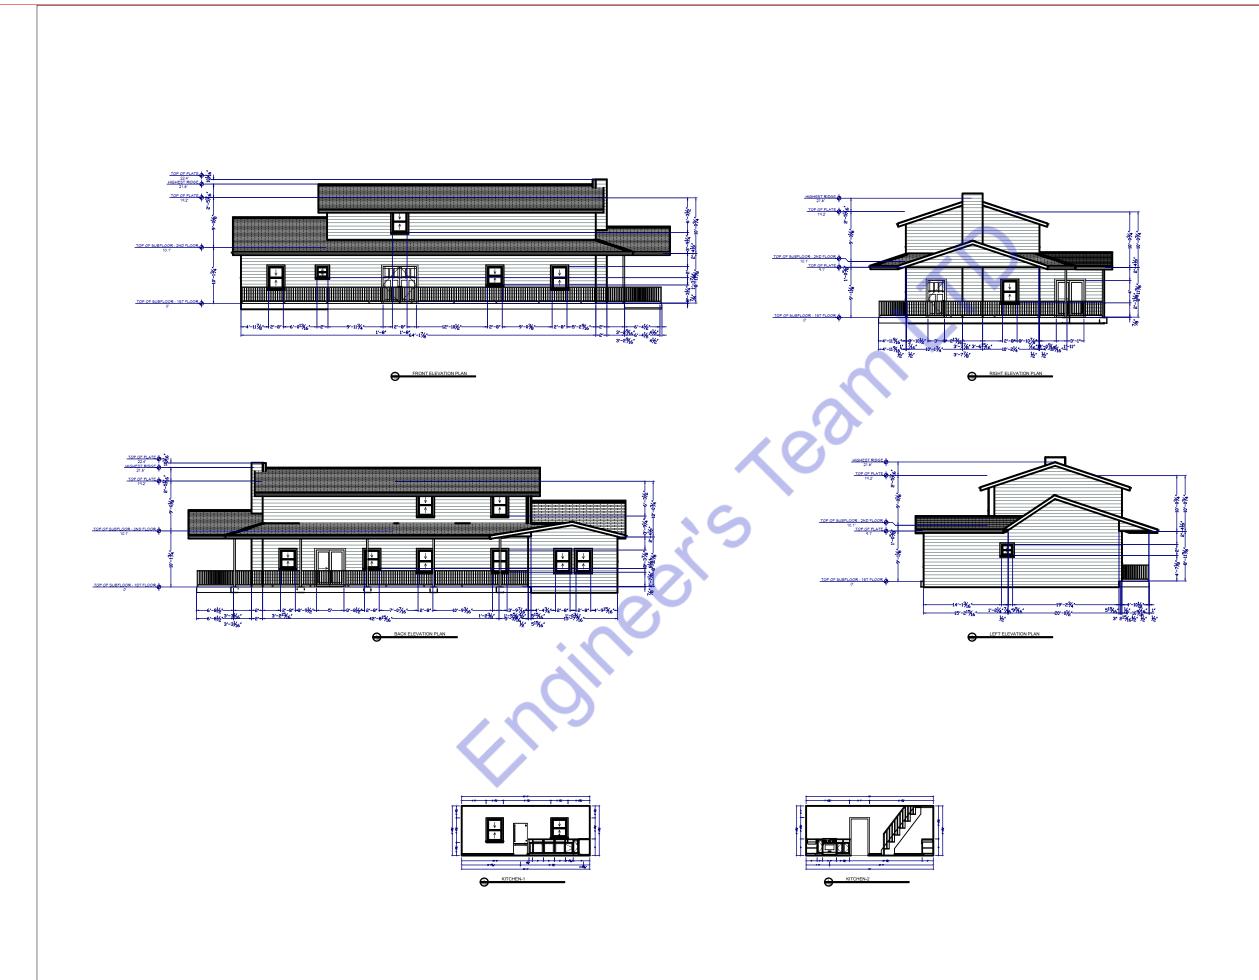



ENGRTEAM.COM

430 E 8TH ST STE 8017 HOLLAND MI 49423

**ENGINEER'S TEAM** 

SUPPORT@ENGRTEAM.COM

OWNER:


8090 County Road 293 Hico Texas, 76457


SEAL:

Release for construction

**ELEVATION PLAN** 

Drawn by:	Engr. Al Amir
Checked:	
Date:	NOV, 24.
	A. 4
Scale:	1:100

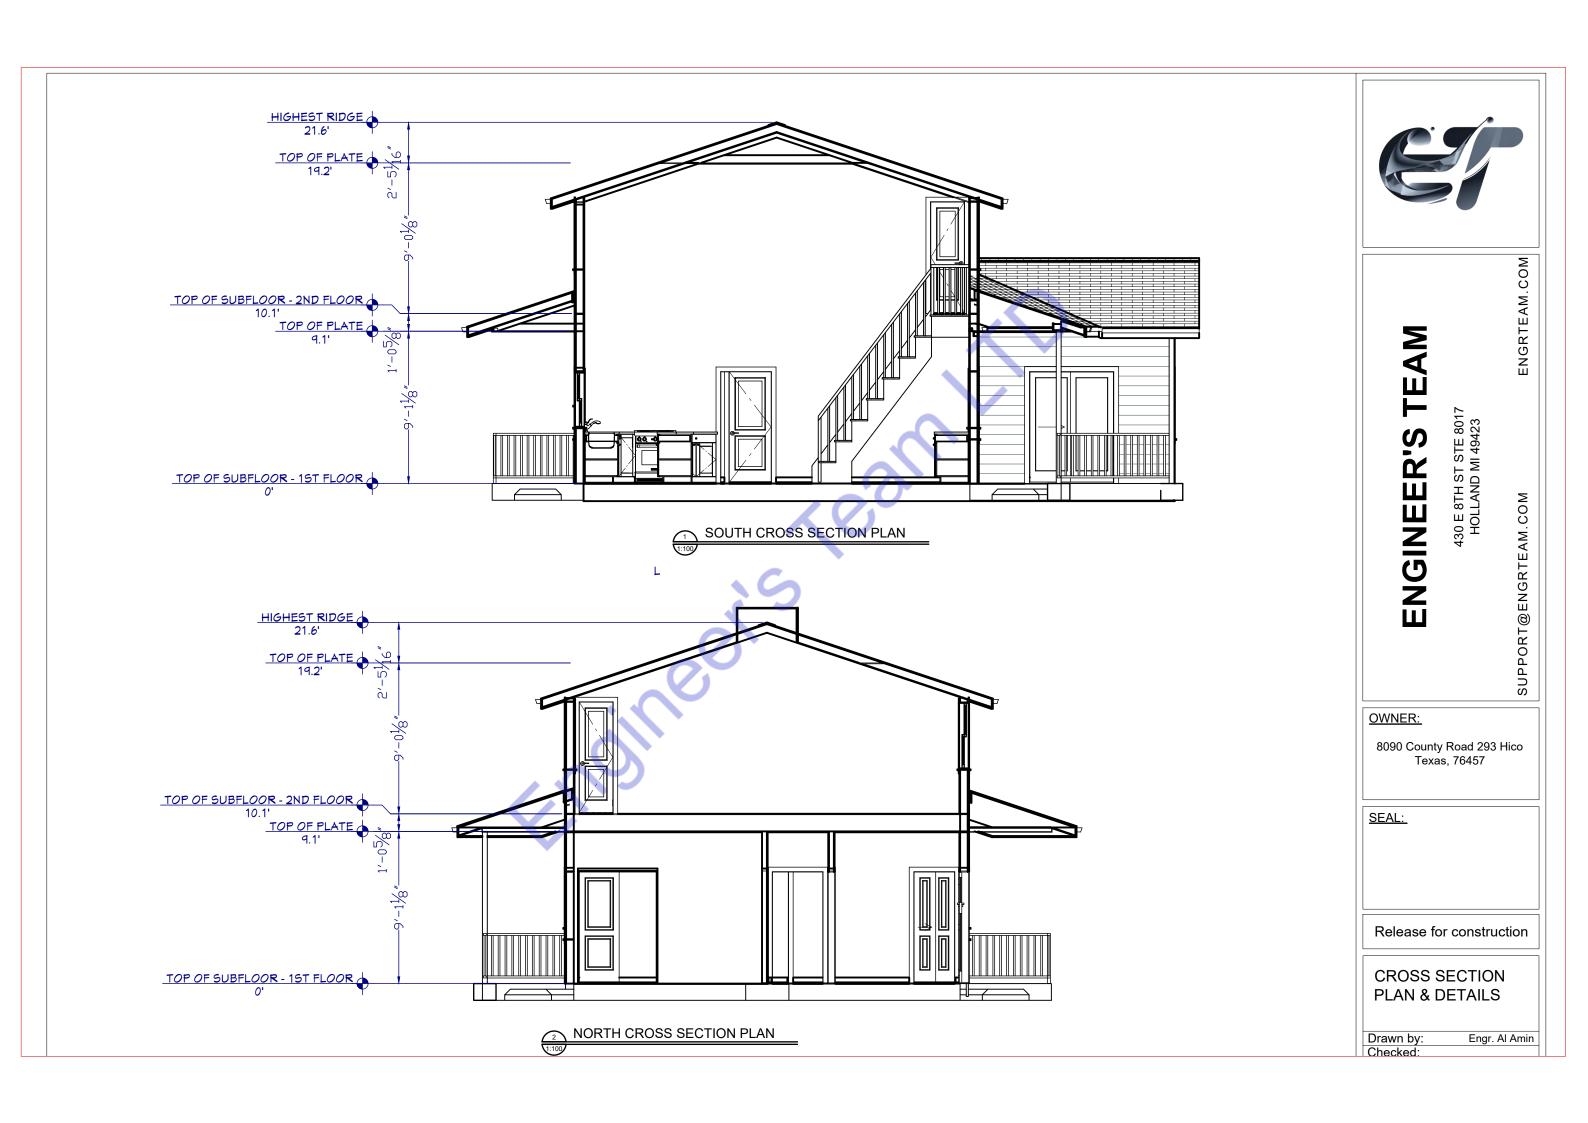

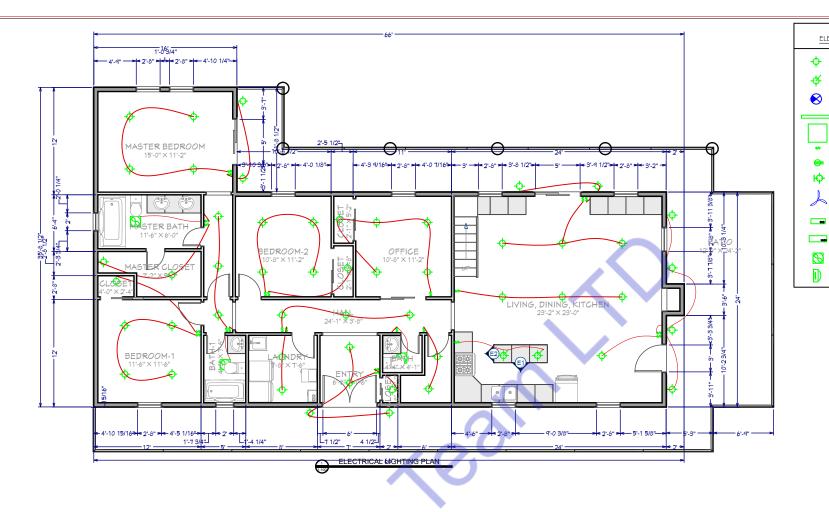





ENGRTEAM.COM

430 E 8TH ST STE 8017 HOLLAND MI 49423

A

Ш

**ENGINEER'S** 

HOLLAIND

SUPPORT@ENGRTEAM.COM

OWNER:


8090 County Road 293 Hico Texas, 76457

SEAL:

Release for construction

# ELECTRICAL LAYOUT PLAN

Drawn by:	Engr. Al Amin
Checked:	
Date:	NOV, 24.
	E. 1
Scale:	1:100

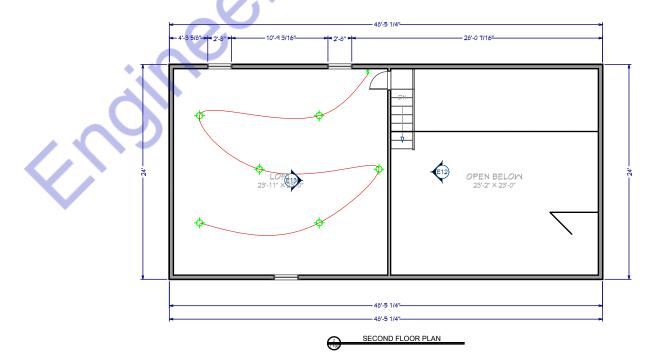


### Note

This Electrical Plan for the property located at 8090 County Road 293, Hico, Texas, 76457, adheres to the most current Texas state and local codes, ensuring both safety and compliance. The following standards were applied:

- National Electrical Code (NEC) 2023: This electrical plan complies with NEC 2023, as adopted by the State of Texas, which governs electrical system safety standards and installations for residential and commercial buildings.
- Texas Administrative Code Title 16, Chapter 73: All licensing and installation requirements meet the Texas Department of Licensing and Regulation's (TDLR) standards for electricians and electrical systems in accordance with the Texas Electrical Safety and Licensing Act.
- Local Hico Amendments and Regulations: Additional local ordinances and any specific amendments or requirements for Erath County, where applicable, have been incorporated into the design to ensure full compliance with the regional standards.

These codes ensure that the design and implementation of electrical systems maintain the highest safety and operational standards, meeting Texas's regulatory and safety requirements.

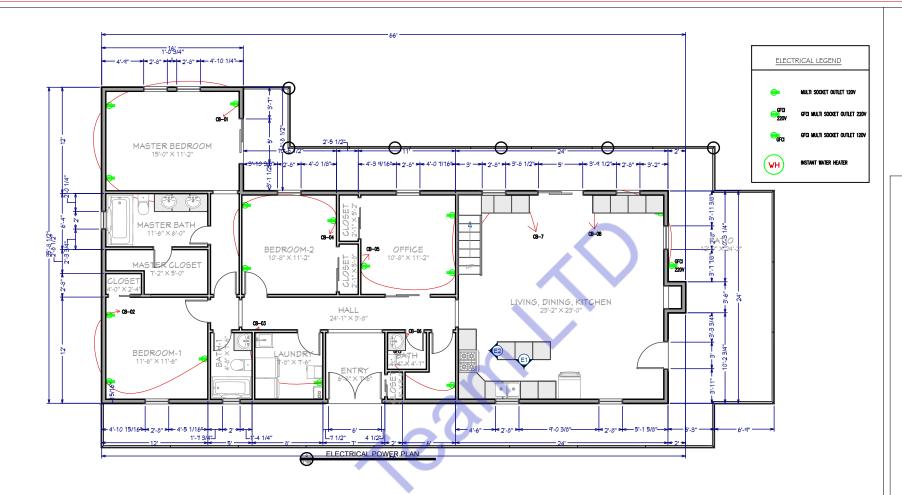

# 48.5 1/4\* 48.5 1/4\* 48.5 1/4\* 48.5 1/4\* 48.5 1/4\* 48.5 1/4\* 48.5 1/4\*

OWNER:

**ENGINEER'S TEAM** 

430 E 8TH ST STE 8017 HOLLAND MI 49423

8090 County Road 293 Hico Texas, 76457

ENGRTEAM.COM

COM

SUPPORT@ENGRTEAM.

SEAL:

Release for construction

# ELECTRICAL LAYOUT PLAN

Drawn by:	Е	ngr. Al Amin
Checked:		
Date:	1	NOV, 24.
	E. 1	
Scale:	1:100	

Note

This Electrical Plan for the property located at 8090 County Road 293, Hico, Texas, 76457, adheres to the most current Texas state and local codes, ensuring both safety and compliance. The following standards were applied:

- National Electrical Code (NEC) 2023: This electrical plan compiles with NEC 2023, as adopted by the State of Texas, which governs electrical system safety standards and installations for residential and commercial buildings.
- Texas Administrative Code Title 16, Chapter 73: All licensing and installation requirements meet the Texas Department of Licensing and Regulation's (TDLR) standards for electricians and electrical systems in accordance with the Texas Electrical Safety and Licensing Act.
- Local Hico Amendments and Regulations: Additional local ordinances and any specific amendments or requirements for Erath County, where applicable, have been incorporated into the design to ensure full compliance with the regional standards.


These codes ensure that the design and implementation of electrical systems maintain the highest safety and operational standards, meeting Texass regulatory and safety requirements.

12	0/240 VOLT SINGLE	PHASE 2 WIRE	ELECTRICAL SERVICE			
ITEM	ITEM CONN. LOAD (VA) DEMAND F. DEMAND LOAD (WATTS)					
LIGHTING	1380	125%	1725			
WATER HEATERS	2000	100%	2000			
EQUIPMENT	5000	65%	3250			
HVAC LOADS	19343	100%	19343			
SUB-TOTAL			26318			
LARGEST MOTOR	0	125%	0			
TOTAL @ 120/208	27723		26318	220		



						ANEL - MAIN					
LOAD SERVED	CKT #	TYPE	BKR TRIP	WIRE SIZE	PHASE A	PHASE A	BKR TRIP	WIRE SIZE	TYPE	CKT #	LOAD SERVED
HVAC-5.5 TONS	1		170	#3/	19343	1380	15	#14		2	LIGHTING LOAD
CB-5	3		20	#12	500	2000	20	#12		4	WATER HEATER
CB-6	5		20	#12	1000	500	20	#12		6	CB-1
CB-7	7		20	#12	500	500	20	#12		8	CB-2
CB-8	9		20	#12	500	4000	40	#8		10	CB-3
CB-9	11		20	#12	500	500	20	#12			CB-4
CB-11	13		20	#12	500	500	20	#12		14	CB-10
TOTAL VA PHASE A					22843	9160					32003
TOTAL VOLT-AMPS											32000
DIVIDE TOTAL VOLT-AMPS BY SYSTEM VOLTAGE (PHASE)					120		AMPS			267	
				/	·\						
	TOTAL CONNECTED LOAD (AMPS) @ 125% 334										
MAIN TYPE AND AMPERE RATING 350 AMP MCCB  PANEL FEEDER SIZE — SEE RISER DIAGRAM											
					P	LE RISER DIAGRAM					

Material	
Name	Watt
CEILING MOUNT ROUND LED LIGHT	20W
WALL MOUNT LED LIGHT	10W
CEILING MOUNT 2"X2" SQUARE LED LIGHT	40W
HANGING LIGHT	20W

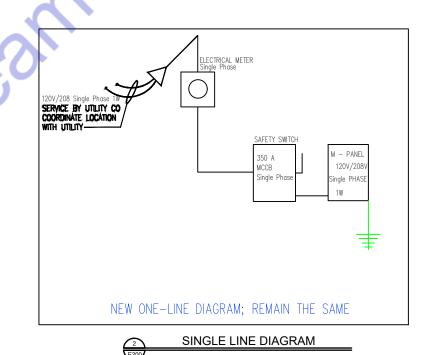



ENGRTEAM.COM

**ENGINEER'S TEAM** 430 E 8TH ST STE 8017 HOLLAND MI 49423

SUPPORT@ENGRTEAM.COM

OWNER:


8090 County Road 293 Hico Texas, 76457


SEAL:


Release for construction


ELECTRICAL LOAD SHEDULE PLAN

Drawn by:		Engr. Al Amin
Checked:		
Date:		NOV, 24.
	E. 2	
Scale:	1:100	

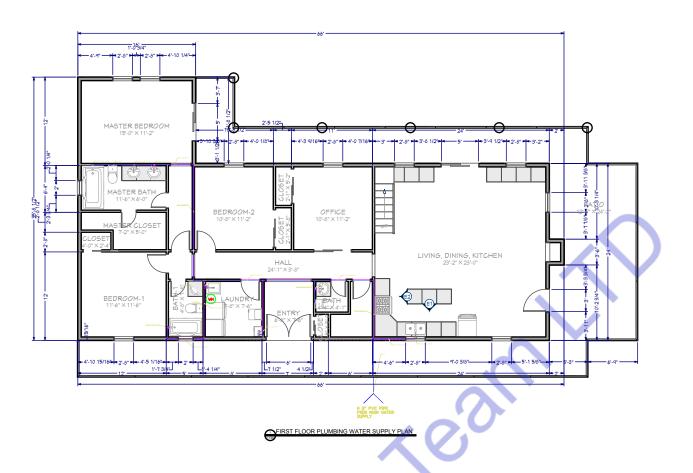

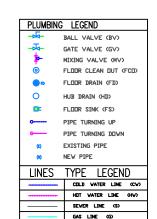

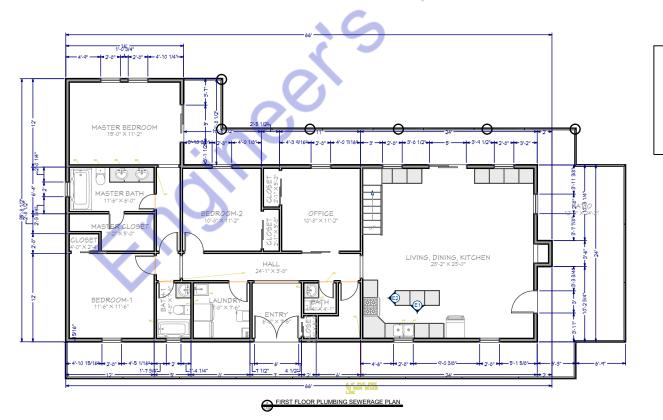

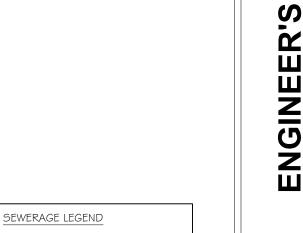

Waste water/ sewer line (upvc pipe)
Toilet waste/ sewer line (upvc pipe)



AM

TE/

ENGRTEAM.COM

430 E 8TH ST STE 8017 HOLLAND MI 49423

SUPPORT@ENGRTEAM.COM

OWNER:

8090 County Road 293 Hico Texas, 76457

SEAL:

Release for construction

PLUMBING PLAN

Drawn by: Engr. Al Amin
Checked:
Date: NOV, 24.


P. 1
Scale: 1:100


Note

Plumbing Plan Compliance Statement

- This plumbing plan for 8090 County Road 293, Hico, Texas, has been designed and developed in strict adherence to the 2021 International Plumbing Code (IPC), adopted by the Texas Department of Licensing and Reputation, which establishes standards for safe plumbing systems and ensures public health, water efficiency, and sustainability.
- This plan complies with updated provisions, such as requirements for backflow prevention, high-efficiency showerheads with a maximum flow rate of 20 gallons per minute, and specific guidelines for drain waste and vent systems to enhance system functionality and reliability.
- Additionally, the plan incorporates the Texas Plumbing License Law requirements and relevant accessibility standards as outlined by the ICC AII7.1 standard, providing measures for universal access and maintaining plumbing infrastructure integrity as per state and federal guidelines.

This comprehensive compliance approach ensures the plan meets all necessary standards, supporting effective plumbing system performance and regulatory approval.

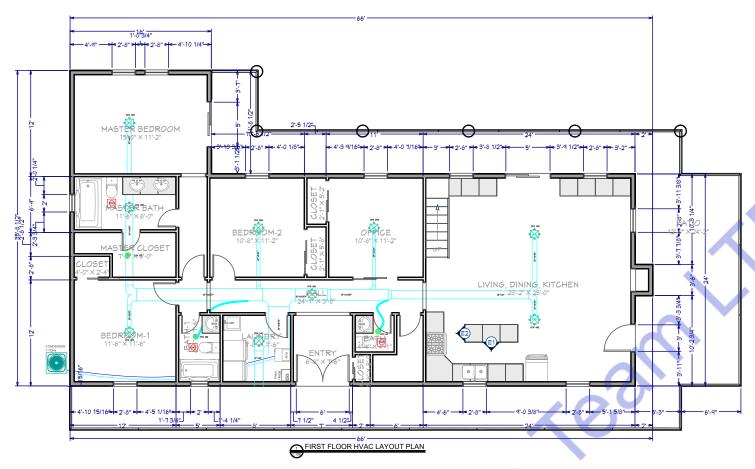

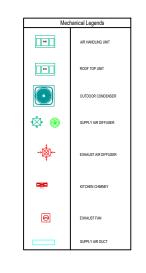



COM

ENGRTEAM.

430 E 8TH ST STE 8017 HOLLAND MI 49423

**ENGINEER'S TEAM** 

SUPPORT@ENGRTEAM.COM

OWNER:


8090 County Road 293 Hico Texas, 76457

SEAL:

Release for construction

**HVAC LAYOUT PLAN** 

Drawn by:	Engr. Al Ami
Checked:	
Date:	NOV, 24.
	H. 1
Scale:	1:100

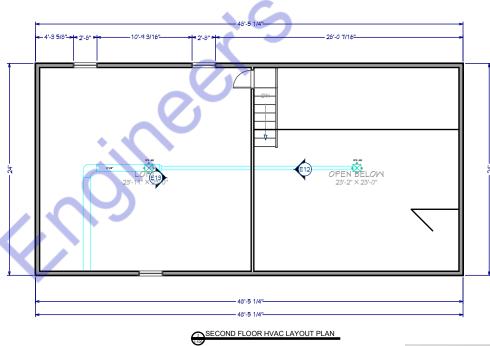

### Note

This HVAC plan has been designed to fully comply with the updated codes and regulations for the location specified, ensuring safe and efficient system operation. The following codes and standards have been applied:

- International Mechanical Code (IMC) 2018 Edition: Compliance with the IMC is required under Texas state guidelines, addressing ventilation, ductwork, exhaust, and mechanical system requirements essential for health and safety.
- International Fuel Gas Code (IFGC) 2018 Edition: This code regulates gas piping installations, including the supply of fuel for HVAC systems, ensuring safe handling and containment within the design.
- International Energy Conservation Code (IECC) 2018 Edition: The plan incorporates the IECC standards for energy efficiency, which guide the insulation, ventilation, and mechanical system controls to optimize energy use in heating, cooling, and ventilation operations.
- 4. Uniform Mechanical Code (UMC) 2018 Edition: As per Texas Administrative Code, Title 16, Rule \$75.100, either the IMC or UMC may be adopted; for this project, UMC requirements were considered to further align with HVAC best practices.
- Each aspect of the HVAC system design adheres to the above codes, reflecting a commitment to quality, safety, and compliance with Texas Department of Licensing and Regulation (TDLR) standards.

This document ensures that the HVAC plan meets local and state regulatory requirements, offering a foundation for safe installation and operation.

EXHAUST FAN SCHEDULE SERVING SP WATTS RPM MAKE NOTES FAN TYPE Broan-NuTone 688 EF-1 BATHROOM 50 460 120/60/1 IN-LINE H00DMART 28D-1600-FF EF-2 KITCHEN 78 1291 115/60/1 IN-LINE


NOTES


1. COMPLETE V/SACKDRAFT DAMPER.

3. INTERLOCK TO DEPRATE V/HENVER RTU'S OPERATE.


2. PROVIDE THERMOSTATIC CONTROL DEVICES


4. MAINTAIN A MODINAL CLEARANCE OF 10°-0° FROM ALL INTAKE AIR FANS AND ALL ROOF TEP UNITS DUTSIDE AIR INTAKE OPENINGS.

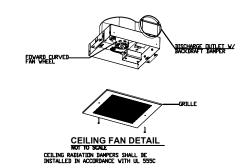


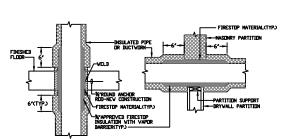

FLOOR OR DECK PENETRATION APPLICABLE TO PENETRATIONS OF ALL FIRE RATED MEMBRANES, IN ACCORDANCE WITH 2012 IBC 714. REFER UL LISTED FIRE STOPPING SYSTEMS UL-1479, UL-2043 PENETRATION OF FIRE/SMOKE BARRIERS

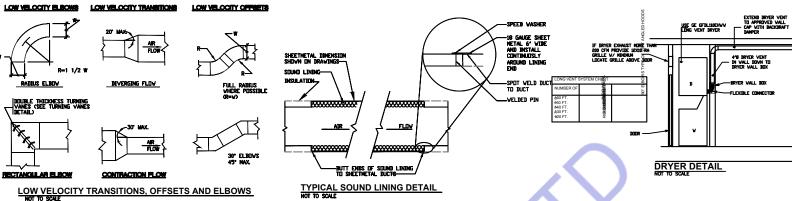

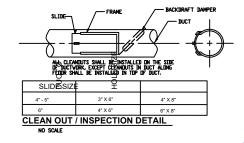

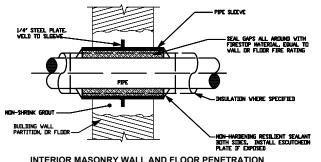


INTERIOR MASONRY WALL AND FLOOR PENETRATION NOT TO SCALE

IAS VENT & COMBUSTION AIR

-PLUG VALVE

GAS-FIRED AIR HANDLING UNIT DETAIL

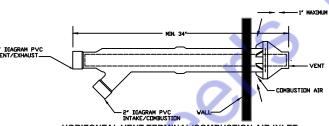

HORIZONTAL VENT TERMINAL/COMBUSTION AIR INLET

HOT TO SQUE

NOT TO SQUE

NOT TO SQUE

NOTE-PLASTIC PIPE AND FITTINGS USED TO VENT APPLIANCE SHALL BE INSTALLED IN


ACCORDANCE WITH THE APPLIANCE MANUFACTURER'S INSTRUCTIONS, PLASTIC PIPE VENTING

MATERIALS, LISTED AND LABELED IN ACCORDANCE WITH UI 1738 SHALL BE INSTALLED IN

ACCORDANCE WITH THE VENT MANUFACTURER'S INSTALLATION INSTRUCTIONS; FLUID PVC PIPING

SHALL NOT BE USED THE COMENSITION GAS VENTING.

	MOU	LATION
		FIRE DAMPER
SEE FLOOR PLAN- FOR DUCT SIZE		ACCESS DOOR (NIN 8"x8")  DAMPER SLEEVE
SDUND BAFFLE ATTENNATING 4* LARGER THE GRILL SIZE A DEFS. CENTER DOR GRILLE BOOK LBUYER SEE ARCHITECT	DUCT BOARD.  AN DOOR  ITTACHED TO  JUR 4' STAND  ED DIVER	CONDENSATE BRAIN PIPE  P-TRAP  VILLINE-MOTORIZED DAMP BISTALLED IN DA. DUCT PROVIDE NOTERIZED DAMP GRENECX NODE. VCDR- GRENECX NODE. VCDR- GRENECX COLOR. VCDR- GRENECX COLOR. VCDR- GRENECX COLOR. VCDR- GRENECX COLOR. VCDR-
STAND OFFS STEEL PLATE	AHU MOUNTING NOT TO SCALE	VOLUME DAMPER  NEUPRENE RIBBED DR  VAFFLE DESIGN PAD  DETAIL

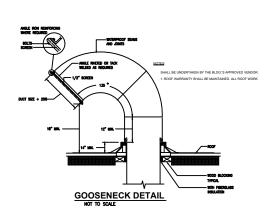

**RESIDENTIAL GRILLES & REGISTERS SCHEDULE** 

6x6 OR 10X4

10x6

12:6

14x6

12x12

6"#

7'4

8"#

9"#

12:12

20x20 20x20 350RL, BORDER TYPE A 22x22 22x22 350RL, BORDER TYPE A

300RL BORDER TYPE A

300RL, BORDER TYPE A

300RL, BORDER TYPE A

350RL, BORDER TYPE A 350RL, BORDER TYPE A

350RL, BORDER TYPE A 350RL, BORDER TYPE A

350RL, BORDER TYPE A

51-100

101-150

151-200

201-250

201-300 301-450

601-800

E REGISTER SA

K RG RA/EA



ENGRTEAM.COM

430 E 8TH ST STE 8017 HOLLAND MI 49423

**ENGINEER'S TEAM** 

SUPPORT@ENGRTEAM.COM

OWNER:

8090 County Road 293 Hico Texas, 76457

SEAL:

Release for construction

**HVAC LAYOUT PLAN** 

Drawn by:		Engr. Al Amin
Checked:		
Date:		NOV, 24.
	H. 2	
Scale:	1:100	



# Designed By Engr. Al Amin (MEP Engineer | Director - Engineer's Team LTD)

support@engrteam.com

https://engrteam.com

# **OUR SERVICES:**

- MEP Plan Services
- > HVAC Layout Plan
- Electrical Engineering Services
- Plumbing Engineering Services
- > Fire protection & Security systems
- Specialized services

## **INFORMATION:**

- > Studio
- Contact Us
- Gift cards
- Privacy Policy
- Refund Policy
- Delivery Policy